

- NOTES**
- ALL PEDESTRIAN SIDEWALKS, PATHWAYS, AND CROSSWALKS SHALL BE CONSTRUCTED NOT TO EXCEED MAX. 2.0% CROSS SLOPE, MAX. 5% RUNNING SLOPE.
 - ALL PLAN ELEVATIONS SHOWN ARE BASED ON THE NORTH AMERICAN VERTICAL DATUM OF 1988 (NAVD 88). ELEVATIONS CAN BE CONVERTED TO THE NATIONAL GEODETIC VERTICAL DATUM OF 1929 (NGVD 29) USING A CONVERSION FACTOR OF +0.97' (NAVD=0.97'+NGVD)
 - PROPOSED GRADES TO MATCH EXISTING ELEVATIONS AT PROPERTY LINE.

- LEGEND**
- 110- EXISTING CONTOUR
 - 111.27- PROPOSED CONTOUR
 - 110.50- EXISTING ELEVATION
 - 111.00- PROPOSED ELEVATION
 - 110.50- PROPOSED PAVEMENT/TOP OF CURB ELEVATION
 - 110.50- PROPOSED DIRECTION OF SURFACE WATER RUNOFF
 - - - - - PROPOSED STORM PIPE
 - ⊕ PROPOSED STORM INLET
 - ⊙ PROPOSED STORM MANHOLE
 - ▒ PROPOSED HEAVY DUTY ASPHALT
 - ▒ CROSSWALK PAVERS
 - ▒ BRICK PAVERS
 - ▒ CONCRETE
 - ▒ HEAVY DUTY CONCRETE
 - ▒ PERVIOUS PAVERS

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 SUNSHINE STATE ONE CALL OF FLORIDA, INC.

Kimley»Horn

LISCENSED PROFESSIONAL
 JAY R. JACKSON, P.E.
 FLORIDA LICENSE NUMBER 54247

KHA PROJECT 149574000
 DATE 01/21/2015
 SCALE AS SHOWN
 DESIGNED BY
 DRAWN BY
 CHECKED BY

PER FHA COMMENTS

1/5/2015 BAL

REVISIONS

DATE

BY

CITY OF ORLANDO

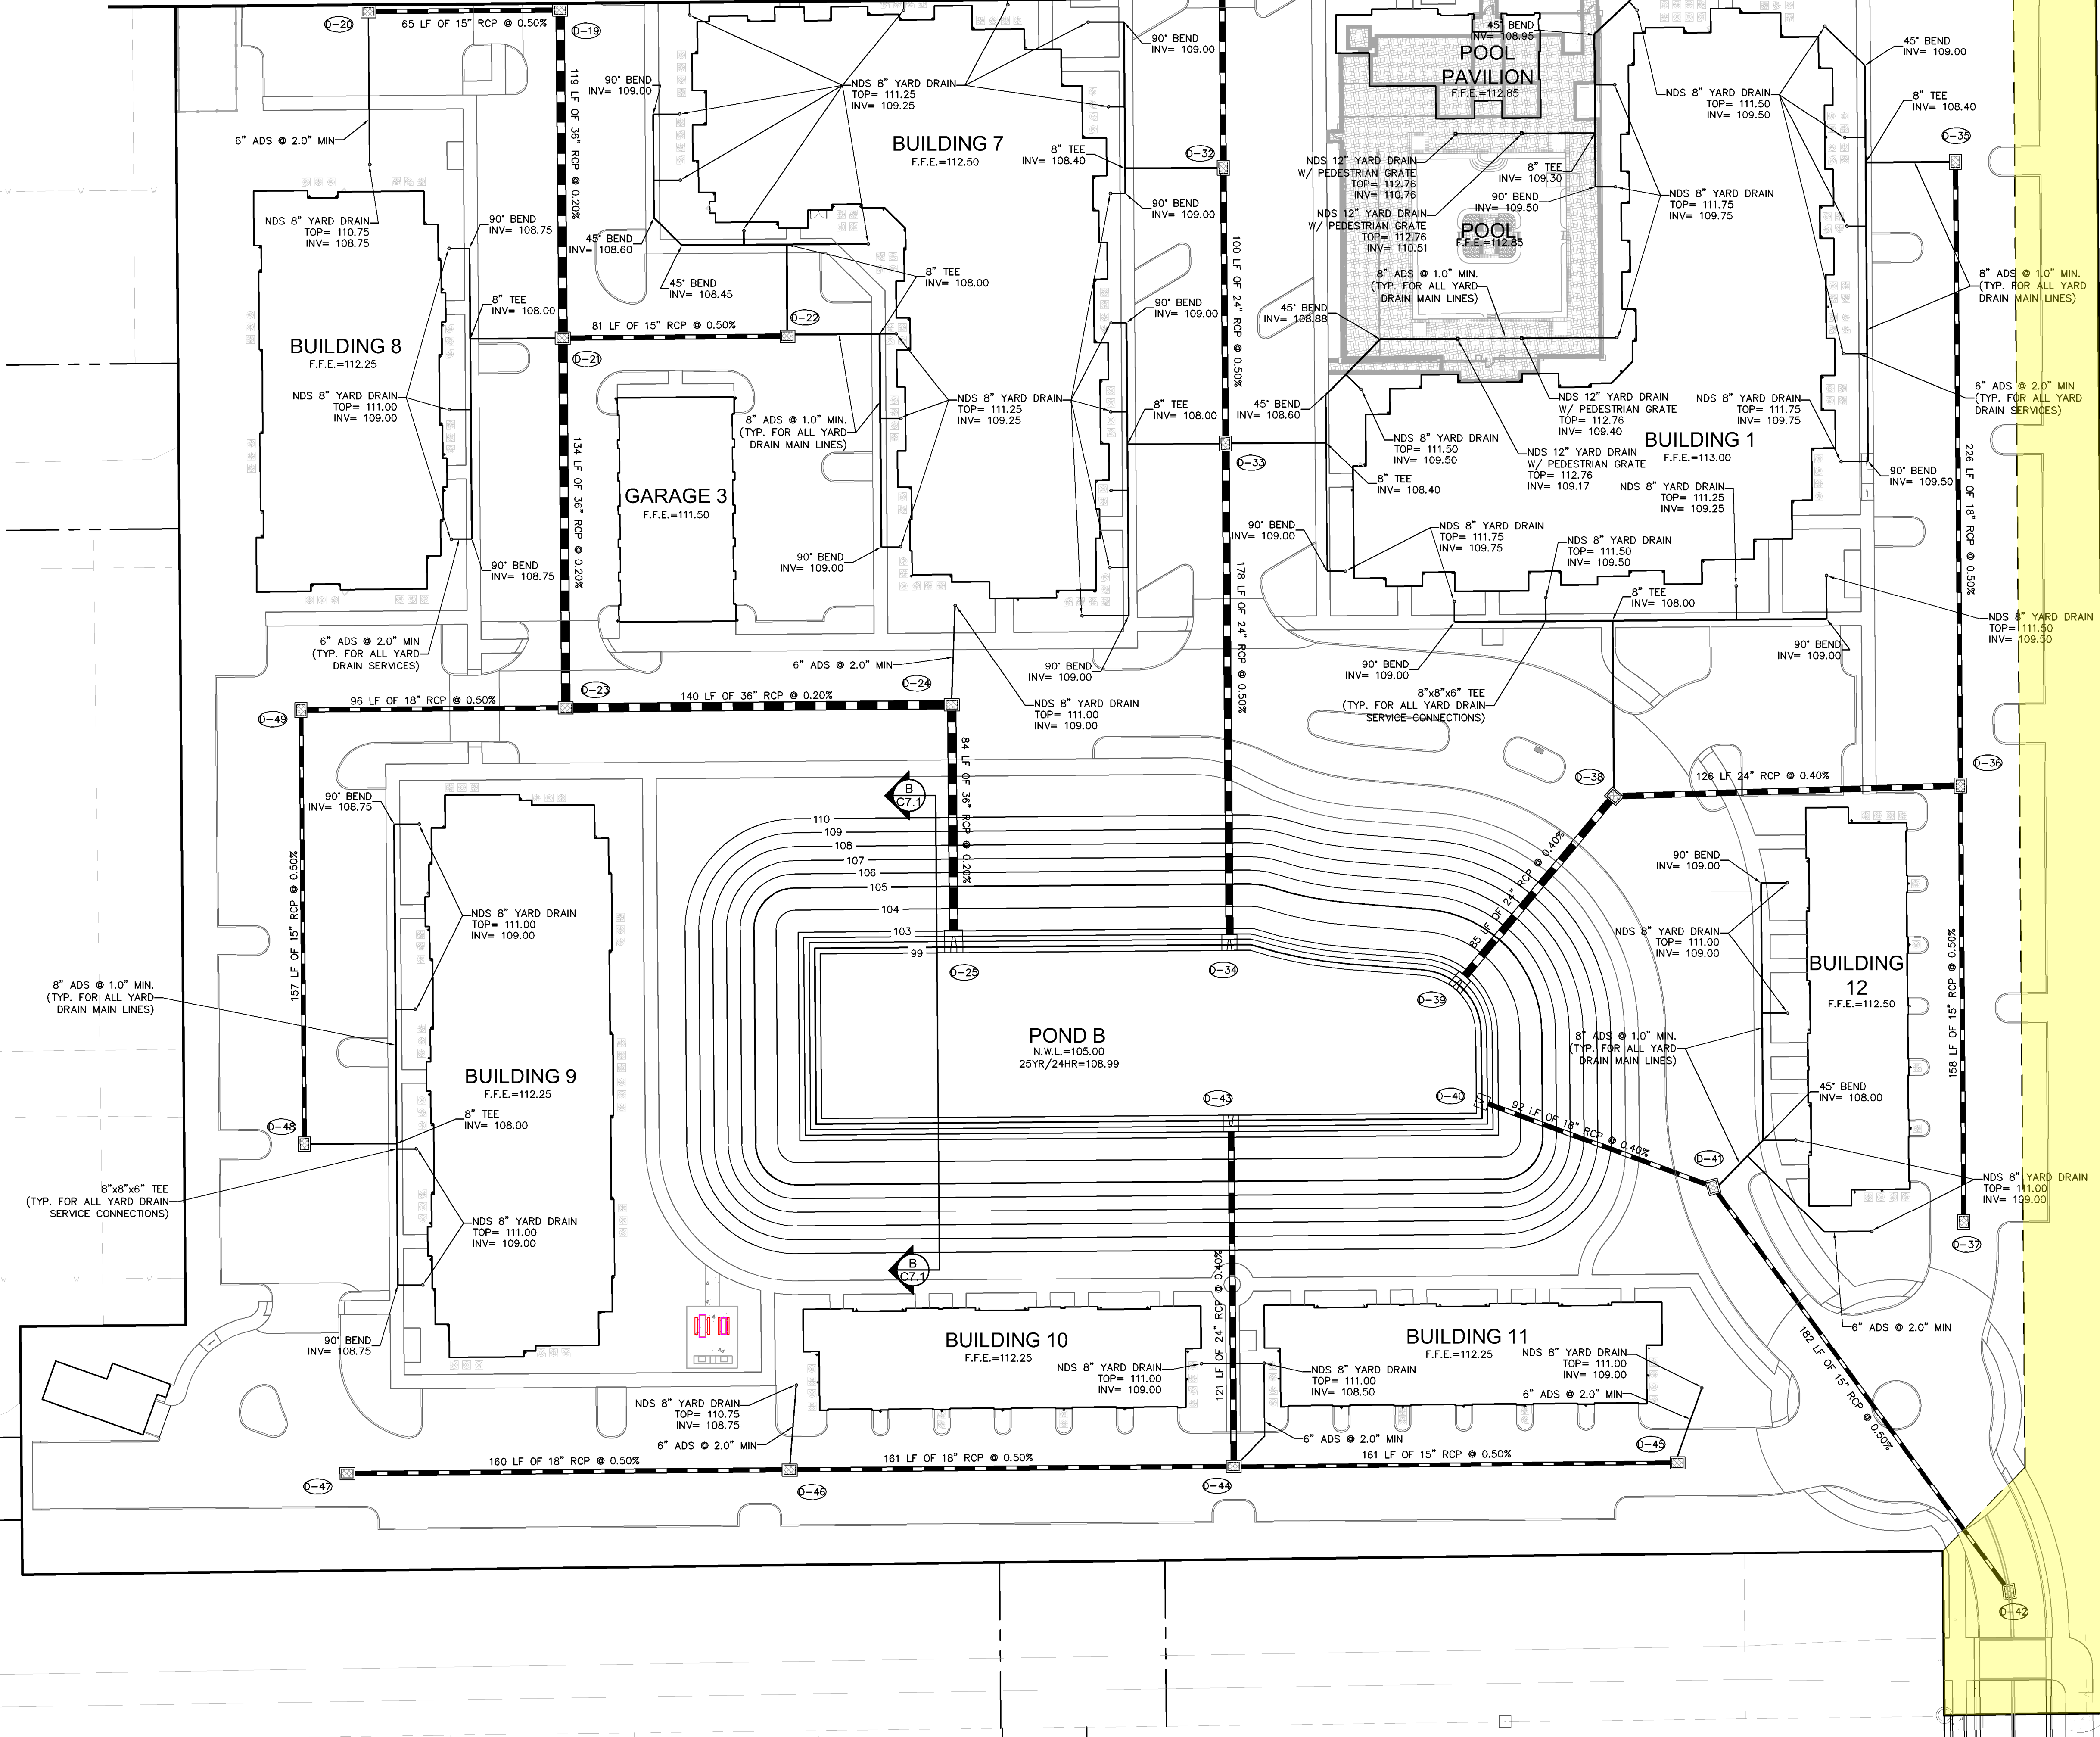
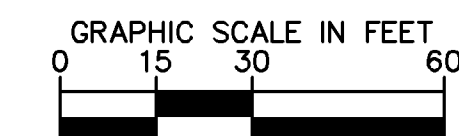
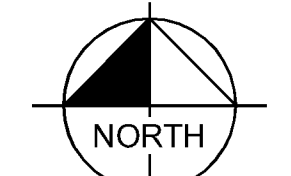
ELAN AUDUBON PARK
 PAVING AND GRADING PLAN

SHEET NUMBER
C4.0

Plotfile: B:\Projects\2015\149574000-Elan Audubon Park - PRELIM\149574000-Elan Audubon Park - Grading\149574000-Elan Audubon Park - Grading - C4.0 - PLOD.dwg
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Plot: ELAN AUDUBON PARK - SHEET: SANITATION PLAN - DRAINAGE - 01/21/2015 - 02:54:33pm - C:\ORL\DWG\149574000-Audubon Park-Sanitation Plan-Sheets\C4.3-C4.3-DRAINAGE.dwg
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MATCHLINE SEE SHEET C4.2



STRUCTURE TABLE

0-19	TYPE "D" INLET PER FDOT INDEX # 232 TOP= 110.50 N. INV= 105.00 E. INV= 103.90 N. & S. INV= 103.02	0-39	TYPE "D" INLET PER FDOT INDEX # 232 TOP= 110.50 N. INV= 105.00 E. INV= 101.65 SW. INV= 99.34
0-20	TYPE "C" INLET PER FDOT INDEX # 232 TOP= 110.25 INV= 104.25	0-38	2:1 MITERED END SECTION PER FDOT INDEX # 272 INV= 99.00
0-21	TYPE "D" INLET PER FDOT INDEX # 232 TOP= 110.00 W. INV= 105.00 E. INV= 104.59 N. & S. INV= 102.78	0-40	2:1 MITERED END SECTION PER FDOT INDEX # 272 INV= 99.00
0-22	TYPE "C" INLET PER FDOT INDEX # 232 TOP= 110.50 INV= 105.00	0-41	TYPE "C" INLET PER FDOT INDEX # 232 TOP= 111.00 E. INV= 107.00 SE. INV= 105.09 NW. INV= 99.37
0-23	TYPE "C" INLET W/ ALT. "A" BOTTOM PER FDOT INDEX # 232 TOP= 110.25 W. INV= 104.73 N. & E. INV= 102.52	0-42	TYPE "C" INLET PER FDOT INDEX # 232 TOP= 111.00 INV= 106.00
0-24	TYPE "C" INLET W/ ALT. "A" BOTTOM PER FDOT INDEX # 232 TOP= 110.25 W. INV= 102.39 E. INV= 105.44 N. INV= 99.49	0-43	2:1 MITERED END SECTION PER FDOT INDEX # 272 INV= 99.00
0-25	2:1 MITERED END SECTION PER FDOT INDEX # 272 INV= 99.00	0-44	TYPE "D" INLET PER FDOT INDEX # 232 TOP= 110.75 NE. INV= 107.00 W. INV= 102.39 E. INV= 105.44 N. INV= 99.49
0-30	TYPE "D" INLET PER FDOT INDEX # 232 TOP= 111.20 W. INV= 107.00 N. & S. INV= 102.65	0-45	TYPE "C" INLET PER FDOT INDEX # 232 TOP= 111.00 INV= 106.25
0-31	TYPE "D" INLET PER FDOT INDEX # 232 TOP= 110.50 W. INV= 107.00 N. & S. INV= 102.65	0-46	TYPE "C" INLET PER FDOT INDEX # 232 TOP= 110.50 N. INV= 106.00 E. & W. INV= 103.20
0-32	TYPE "D" INLET PER FDOT INDEX # 232 TOP= 110.85 E. & W. INV= 106.50 N. INV= 102.15 S. INV= 99.89	0-47	TYPE "C" INLET PER FDOT INDEX # 232 TOP= 110.00 INV= 104.00
0-33	2:1 MITERED END SECTION PER FDOT INDEX # 272 INV= 99.00	0-48	TYPE "C" INLET PER FDOT INDEX # 232 TOP= 110.00 INV= 106.00
0-34	TYPE "C" INLET PER FDOT INDEX # 232 TOP= 110.65 INV= 105.15	0-49	TYPE "C" INLET PER FDOT INDEX # 232 TOP= 110.00 INV= 105.21
0-35	TYPE "D" INLET PER FDOT INDEX # 232 TOP= 111.00 N. INV= 104.02 S. INV= 106.46 W. INV= 102.15		
0-36	TYPE "D" INLET PER FDOT INDEX # 232 TOP= 111.25 INV= 107.25		

NOTES

- ALL YARD DRAIN MAIN LINES ARE TO BE 8" ADS AT 1.0% MINIMUM SLOPE. ALL SERVICE LINES TO YARD DRAINS ARE TO BE 6" ADS AT 2.0% MINIMUM SLOPE.
- BUILDING ROOF DOWNSPOUTS THAT ARE NOT PROVIDED STORMWATER COLLECTION PIPING ARE TO SHEET FLOW AT THE GROUND LEVEL INTO THE PROVIDED YARD DRAINS.

LEGEND

- PROPOSED STORM PIPE
- PROPOSED STORM INLET
- PROPOSED STORM MANHOLE
- PROPOSED MITERED END SECTION

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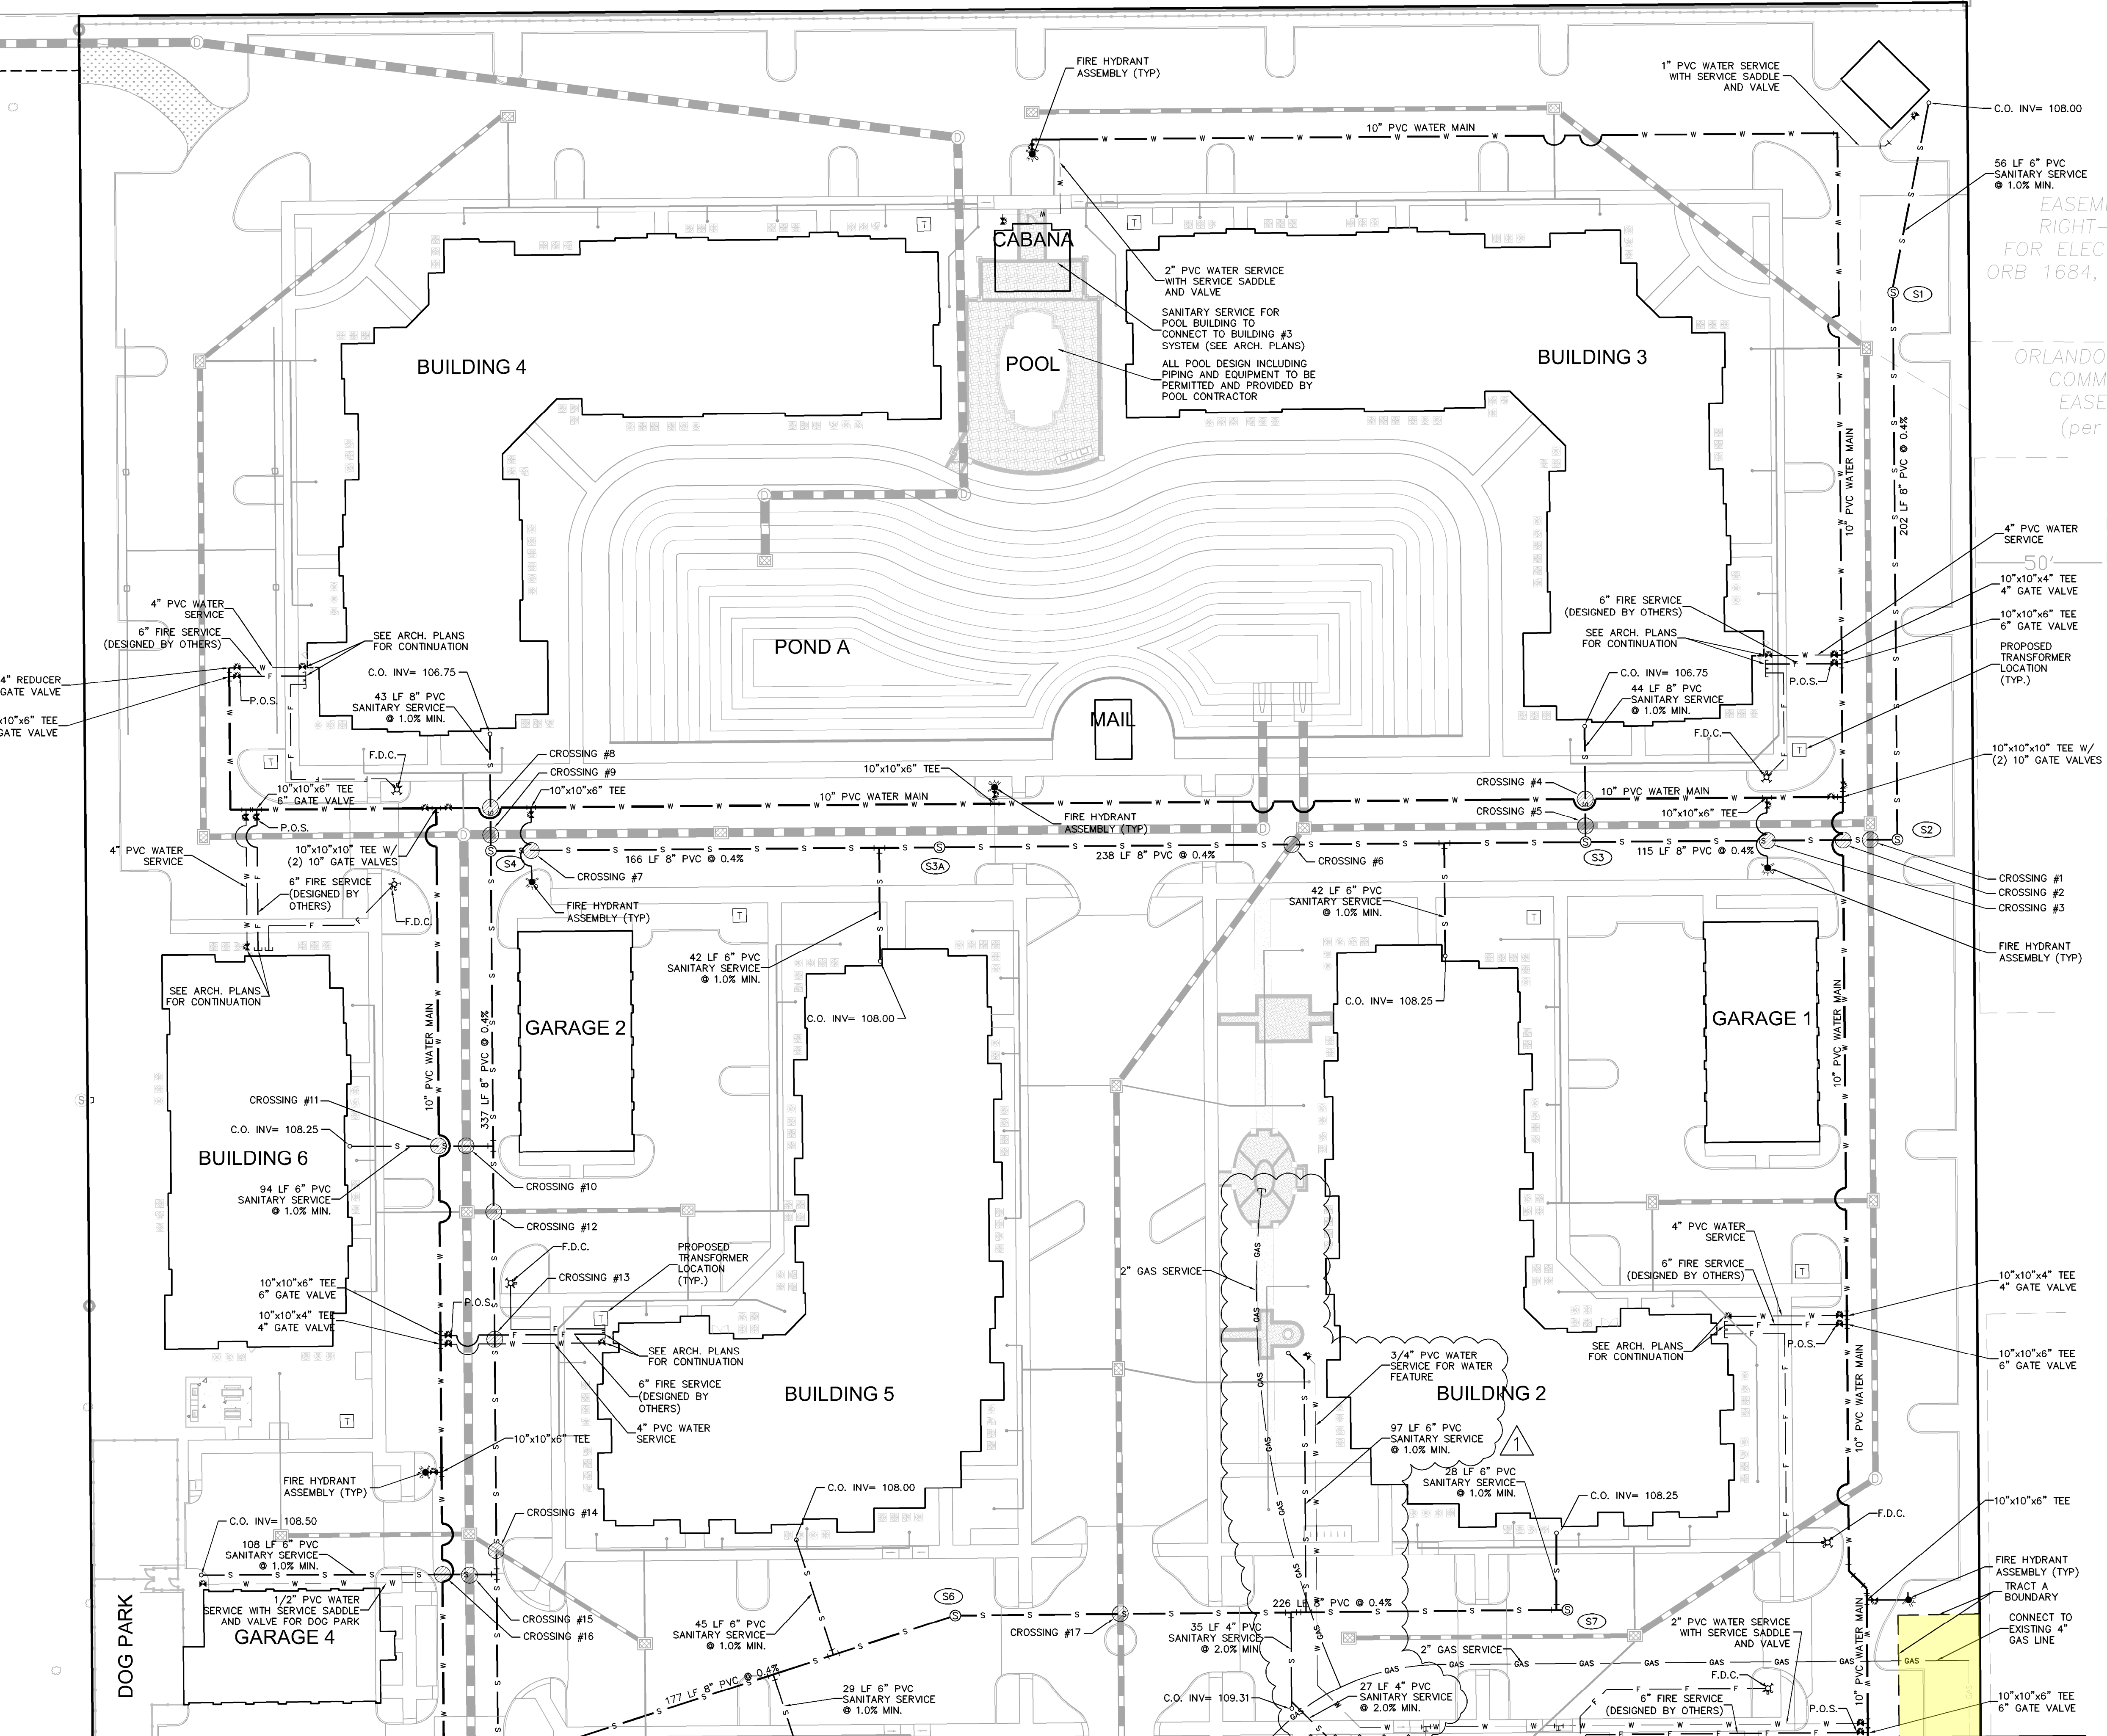
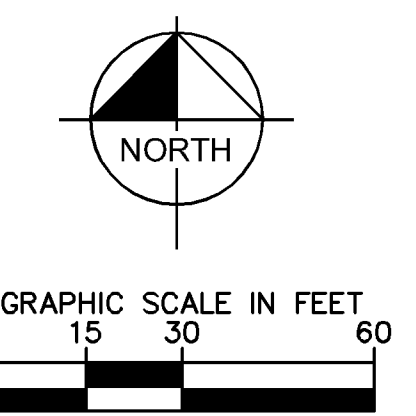
811

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SUNSHINE STATE ONE CALL OF FLORIDA, INC.

<h1 style="margin: 0;">Kimley»Horn</h1> <p style="font-size: small; margin: 0;"> © 2015 KIMLEY-HORN AND ASSOCIATES, INC. 3660 MAGUIRE BOULEVARD, SUITE 200, ORLANDO, FL 32803 PHONE: 407-898-1511 WWW.KIMLEY-HORN.COM CA 00000696 </p>	<p style="font-size: x-small; margin: 0;">LICENSED PROFESSIONAL</p> <p style="font-size: x-small; margin: 0;">KHA PROJECT 149574000</p> <p style="font-size: x-small; margin: 0;">DATE 01/21/2015</p> <p style="font-size: x-small; margin: 0;">SCALE AS SHOWN</p> <p style="font-size: x-small; margin: 0;">DESIGNED BY JAY R. JACKSON, P.E.</p> <p style="font-size: x-small; margin: 0;">DRAWN BY</p> <p style="font-size: x-small; margin: 0;">CHECKED BY</p> <p style="font-size: x-small; margin: 0;">FLORIDA LICENSE NUMBER 54247</p>
<h2 style="margin: 0;">DRAINAGE PLAN</h2>	<p style="font-size: x-small; margin: 0;">CITY OF ORLANDO</p>
<h3 style="margin: 0;">ELAN AUDUBON PARK</h3>	<p style="font-size: x-small; margin: 0;">SHEET NUMBER</p> <h2 style="margin: 0;">C4.3</h2>
<p style="font-size: x-small; margin: 0;">NO.</p> <p style="font-size: x-small; margin: 0;">REVISIONS</p> <p style="font-size: x-small; margin: 0;">DATE</p>	<p style="font-size: x-small; margin: 0;">BY</p>

Plot: ELAN_AUDUBON_PARK - SHEET - SANITARY - 01/21/2015 - 09:57:33am - K:\DRL - 0149574000 - Audubon Park - Gravel - CAD - CONST - Pipe - 05 - 05 - UTILITY.dwg
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SANITARY STRUCTURE TABLE

Structure ID	Structure Type	Top Elevation	North Inlet Elevation	South Inlet Elevation
S1	SANITARY MANHOLE	TOP= 110.16	N INV= 106.20	S INV= 106.06
S2	SANITARY MANHOLE	TOP= 110.05	N INV= 105.25	W INV= 105.15
S3	SANITARY MANHOLE	TOP= 111.04	E INV= 104.69	N INV= 105.59
S3A	SANITARY MANHOLE	TOP= 110.54	E INV= 103.64	W INV= 103.54
S4	SANITARY MANHOLE	TOP= 110.57	N INV= 106.32 (DROP)	E INV= 102.88
S5	SANITARY MANHOLE	TOP= 110.54	N INV= 101.43	E INV= 105.45 (DROP)
S6	SANITARY MANHOLE	TOP= 111.32	E INV= 106.26	W INV= 106.16
S7	SANITARY MANHOLE	TOP= 111.37	W INV= 107.16	

LEGEND

	EXISTING WATER MAIN
	EXISTING FORCE MAIN
	EXISTING GAS MAIN
	EXISTING STORM PIPE
	EXISTING METERED END SECTION
	EXISTING STORM INLET
	EXISTING FIRE HYDRANT
	PROPOSED WATER LINE
	PROPOSED FIRE LINE
	PROPOSED FIRE HYDRANT
	PROPOSED F.D.C.
	PROPOSED SANITARY LINE
	PROPOSED FORCE MAIN
	PROPOSED SANITARY MANHOLE
	PROPOSED STORM PIPE
	PROPOSED STORM INLET
	PROPOSED STORM MANHOLE
	PROPOSED METERED END SECTION
	PROPOSED TRANSFORMER
	PROPOSED GAS LINE

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UTILITY PLAN

ELAN AUDUBON PARK

CITY OF ORLANDO FLORIDA

SHEET NUMBER **C5.0**

NO.	REVISIONS	DATE	BY

PER CITY AND OWNER COMMENTS
 3/11/2015 BAL

