Magnolia Dental Center

Addition and Renovation

Appearance Review Board Minor Review Application

611 Magnolia Avenue,

Orlando, Florida 32901

CONCEPT ARCHITECT

Issue Date



1422 delgany street, suite LL denver, colorado 80202 † 720.946.3228 f 720.946.3004 www.joearchitect.com



WJ WEEKS ARCHITECTURE LLC

1200 EAST HILLCREST STREET, SUITE 200 ORLANDO, FLORIDA 32803 407-234-3695

ARCHITECT OF RECORD

Project Directory

Client:

Mandana Nabizadeh, DDS & Ali Behzadi, DMD

Architect of Record:

WJ WEEKS Archtecture IIc AA26002407 1200 East Hillcrest Street Suite 200

Orlando, Florida 32803

407.234.3695 407.888.4930 (fax)

Design Architect:

JoeArchitect, Inc.

1422 Delgany Street, Suite LL1

Denver, CO. 80202

720.946.3228

720.946.3004 (fax)

Civil Engineer:

SK Consortium Inc. EB 7080

1053 North Orlando Avenue Suite 3

Maitland, Florida 32751

407.629.4288

407.629.1656 (fax)

Landscape Architect:

Daniel A. Rodgers

230 North Glenwood Avenue

Orlando, Florida 32751

407.353.0112

Structural Engineer:

RDI Structural Engineering, Inc. CA 29982

1135 Pasadena Avenue South Suite 100

South Pasadena, Florida 33707

727.388.1344

MEP Engineers:

RBE Consulting Services LLC #27269

2875 Split Oak Court

Oviedo, Florida 32766

407.796.3820 407.796.3671fax)

Dental Equipment Provider:

Patterson Dental

Mike Cothern

407.923.5037

jcothern@pattersondental.com

Building Code Summary

Applicable Codes:

CO

Scope of Work:

floor of existing 1 story, fully sprinkled, type V-B building

2012 Florida Building Code 2008 National Electrical Code

2010 Mechanical Code

2010 Fuel Gas Code

2010 Florida Energy Code

2010 Plumbing Code 2010 florida Fire Preservation Code

2,192 sq. ft. interior tenant finish on 1st

2009 NFPA 1 Uniform Fire Code w/ Florida Amendments Engineering Standards Manual

2009 NFPA 101 Life Safety Code w/ Florida Amendments

Orlando Urban Storm Water Management Manual

Orlando City Code

Occupancy Classification:

Construction Type:

Tenant Finish Area: 2,192 sq. ft.

2,374 sq. ft. Gross Building Area:

Building Height: 1 story

1 occupant / 100 sq. ft. Occupant Load Factor:


Occupant Load:

Total Exit Width: (0.2"/occupant) * 22 occupants = 4.4" 32" minimum clear width reg'd.

Number of Exits Required: 1 exit required, ? exits provided

Max. Travel Distance to Exit: 200 ft allowed (non sprinkled) 56 ft maximum travel distance

Fire Protection: Existing building non sprinklered

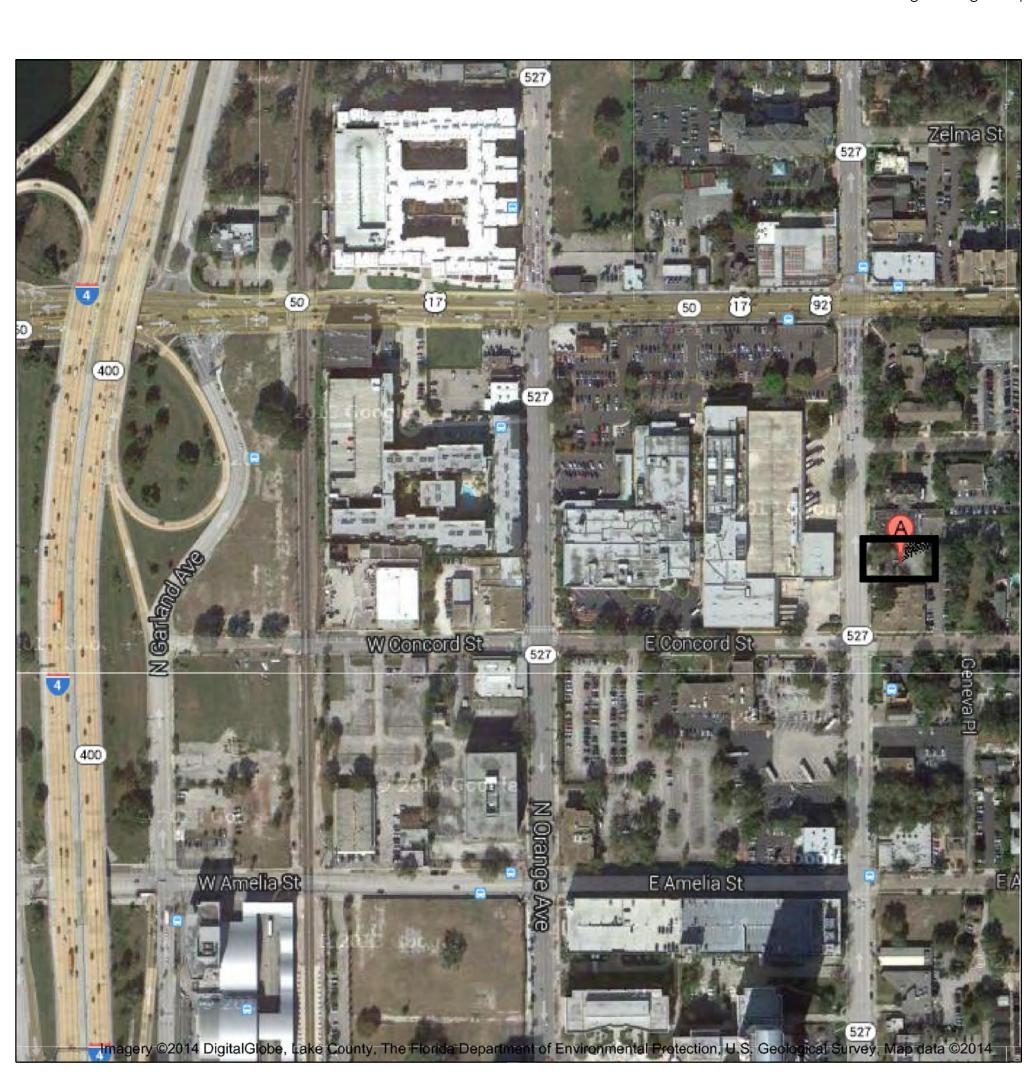

VICINITY MAP

SCALE: N/A

	E2.1	Lighting Floor Plan	1	1					
	E3.1	Electrical Roof Plan	1	1					
	E4.1	Power Riser Diagram, Details and Schedules	1	1					
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Drawing Index

Sheet Name

Sheet #

C001

LA - 100

E0.2

Cover

Roof Plan

Demolition Floor Plan

Existing Exterior Elevations

New Exterior Elevations

New Exterior Elevations

New Floor Plan

Existing Photos

Detail Sheet

Existing Tree Plan

Color Renderings

Demolition Site Plan

Site Development Plan

Grading and Drainage Plan

Landscape Planting Details

Irrigation Plan Details & Notes

Electrical Site Photometric Plan

Electrical Power & Systems Plans

Landscape Plan & Plant Palette

ARCHITECTURE CO

CIVIL

LANDSCAPE

ELECTRICAL

2	SITE LOCATION
CO	SCALE: N/A

AA 26002407 AR 95341 **MAGNOLIA**

DENTAL CENTER 611 NORTH MAGNOLIA

ORLANDO, FLORIDA

PROJECT NUMBER 2013-0023

OWNER/DEVELOPER NAME

NAZAK HOLDINGS LLC **515 STATE ROAD 436**


CASSELBERRY, FLORIDA PROJECT TEAM

SUITE 1010

BUILDING PERMIT
APPLICATION 2 5-26-14

DRAWING NAME:


COVER SHEET

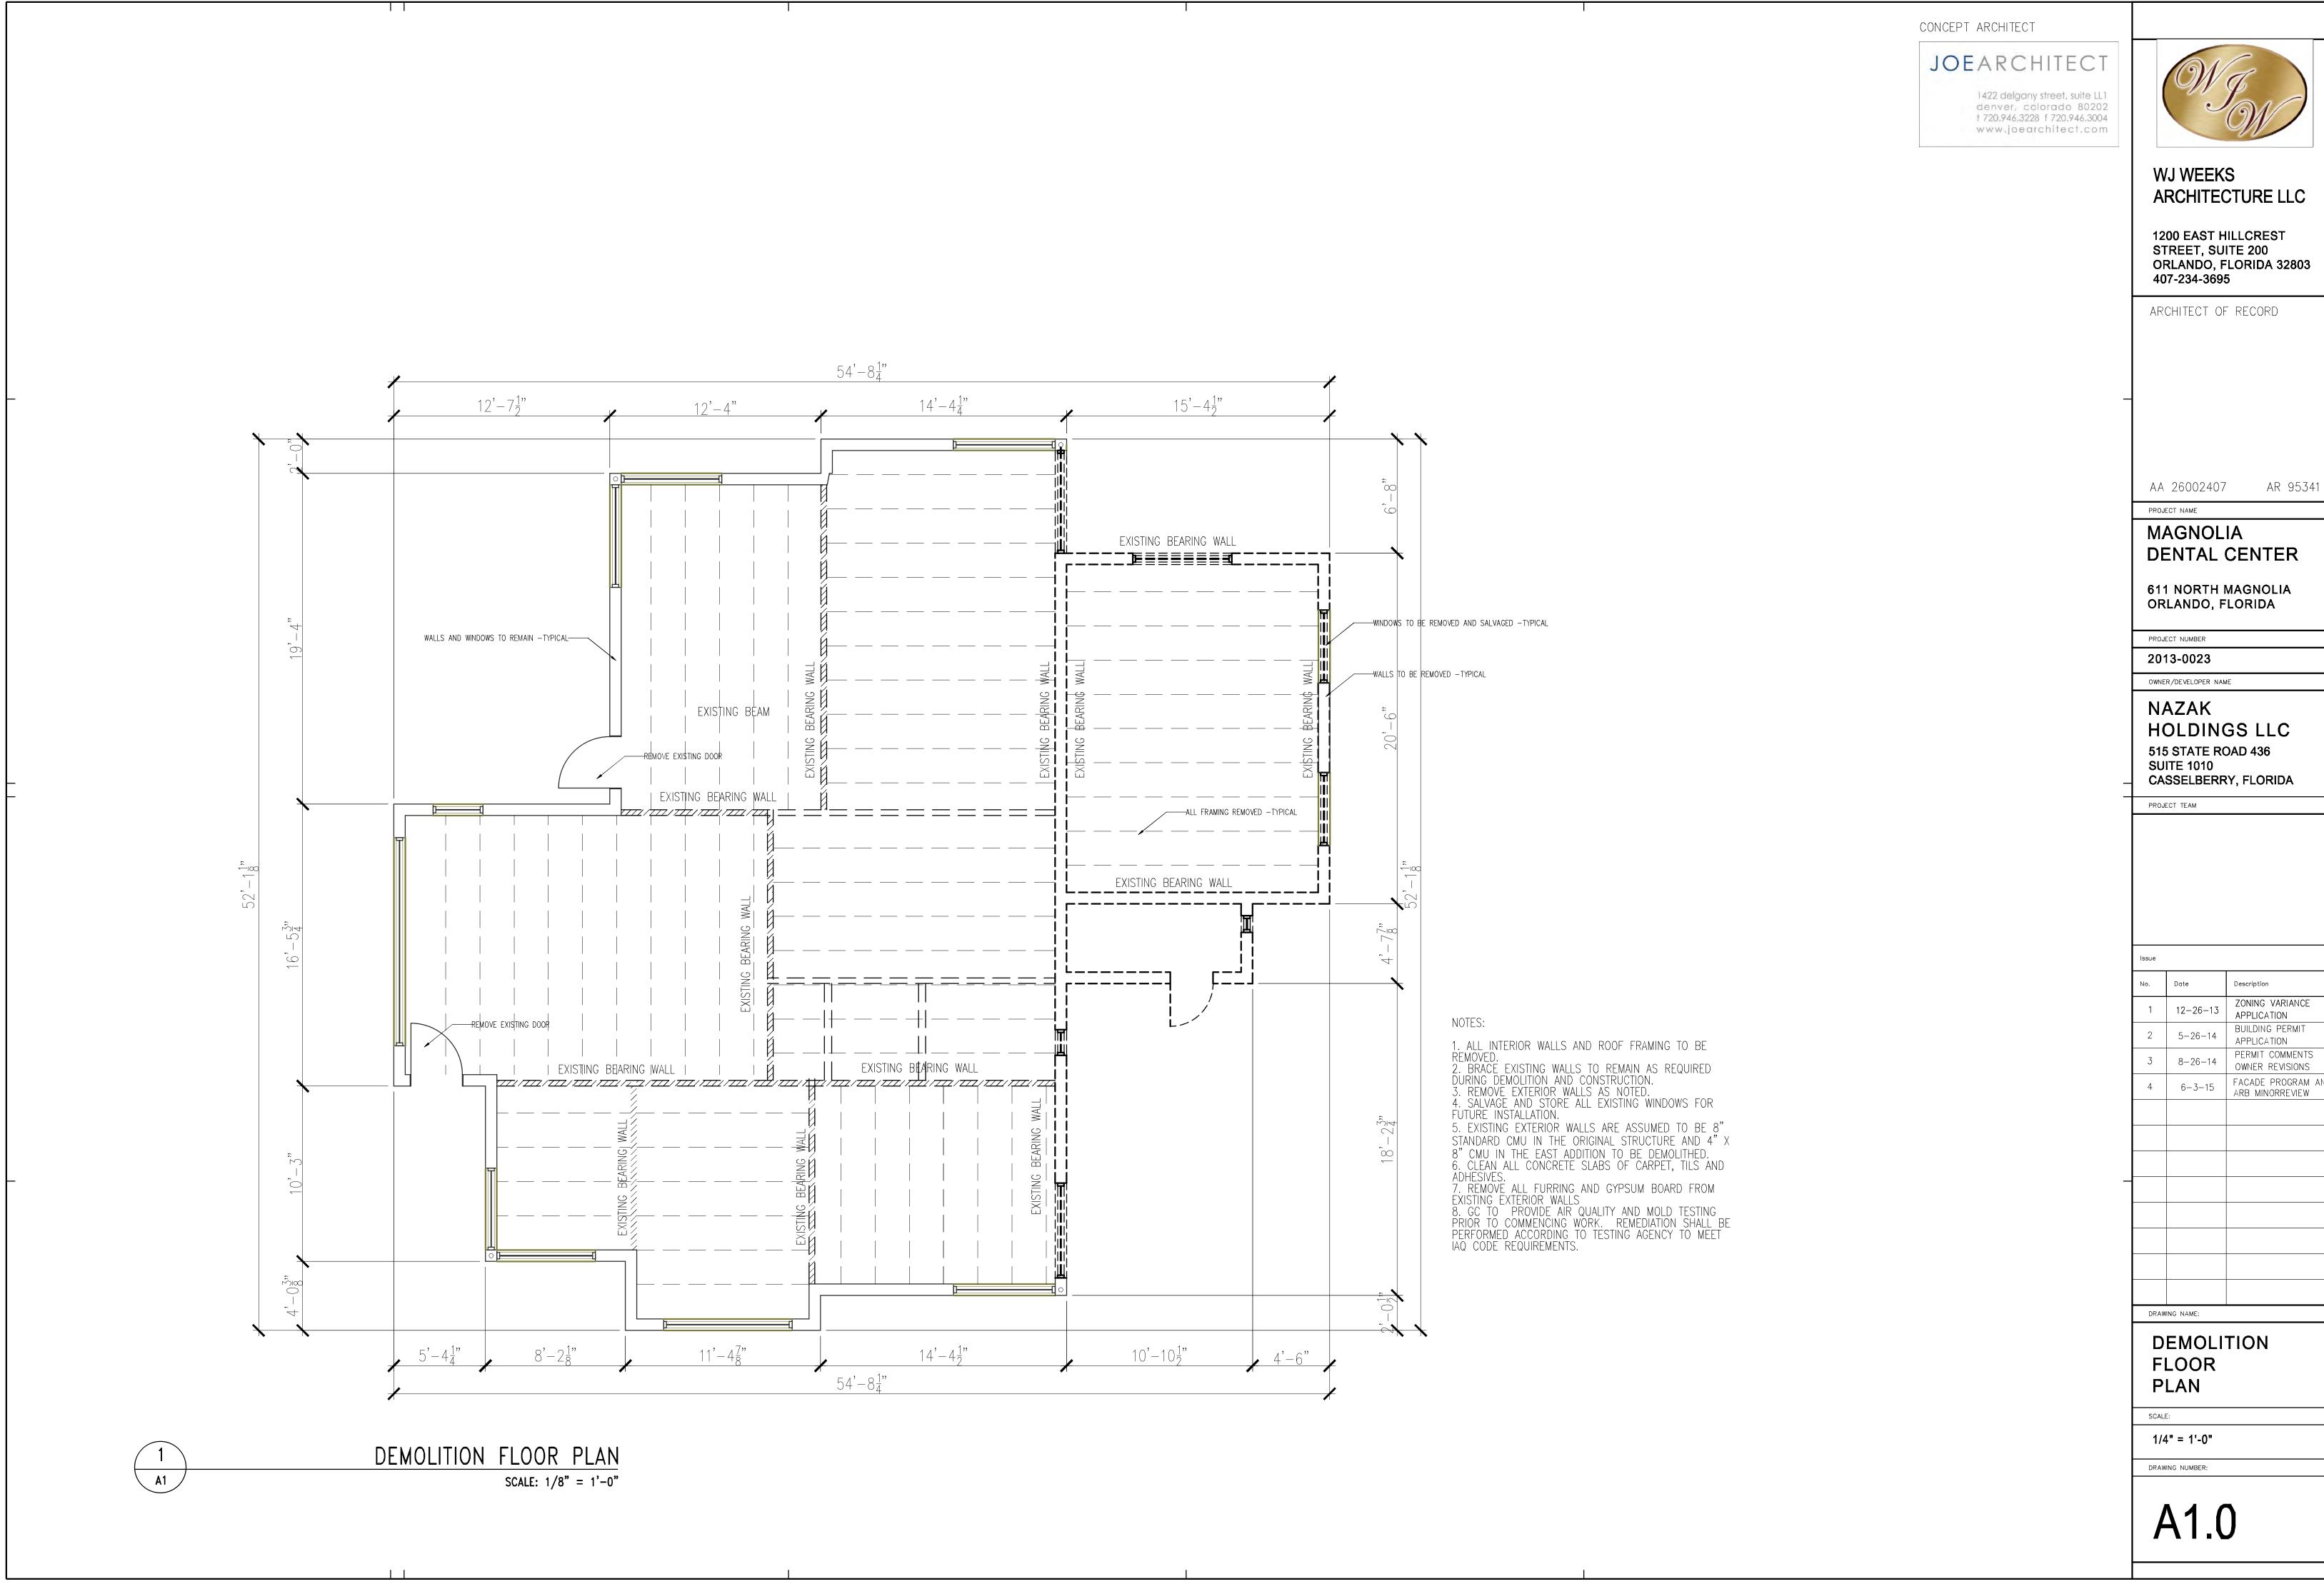




ORLANDO, FLORIDA 32803

No.	Date	Description
1	12-26-13	ZONING VARIANCE APPLICATION
2	5-26-14	BUILDING PERMIT APPLICATION
3	8-26-14	PERMIT COMMENTS OWNER REVISIONS
4	6-3-15	FACADE PROGRAM AI ARB MINORREVIEW

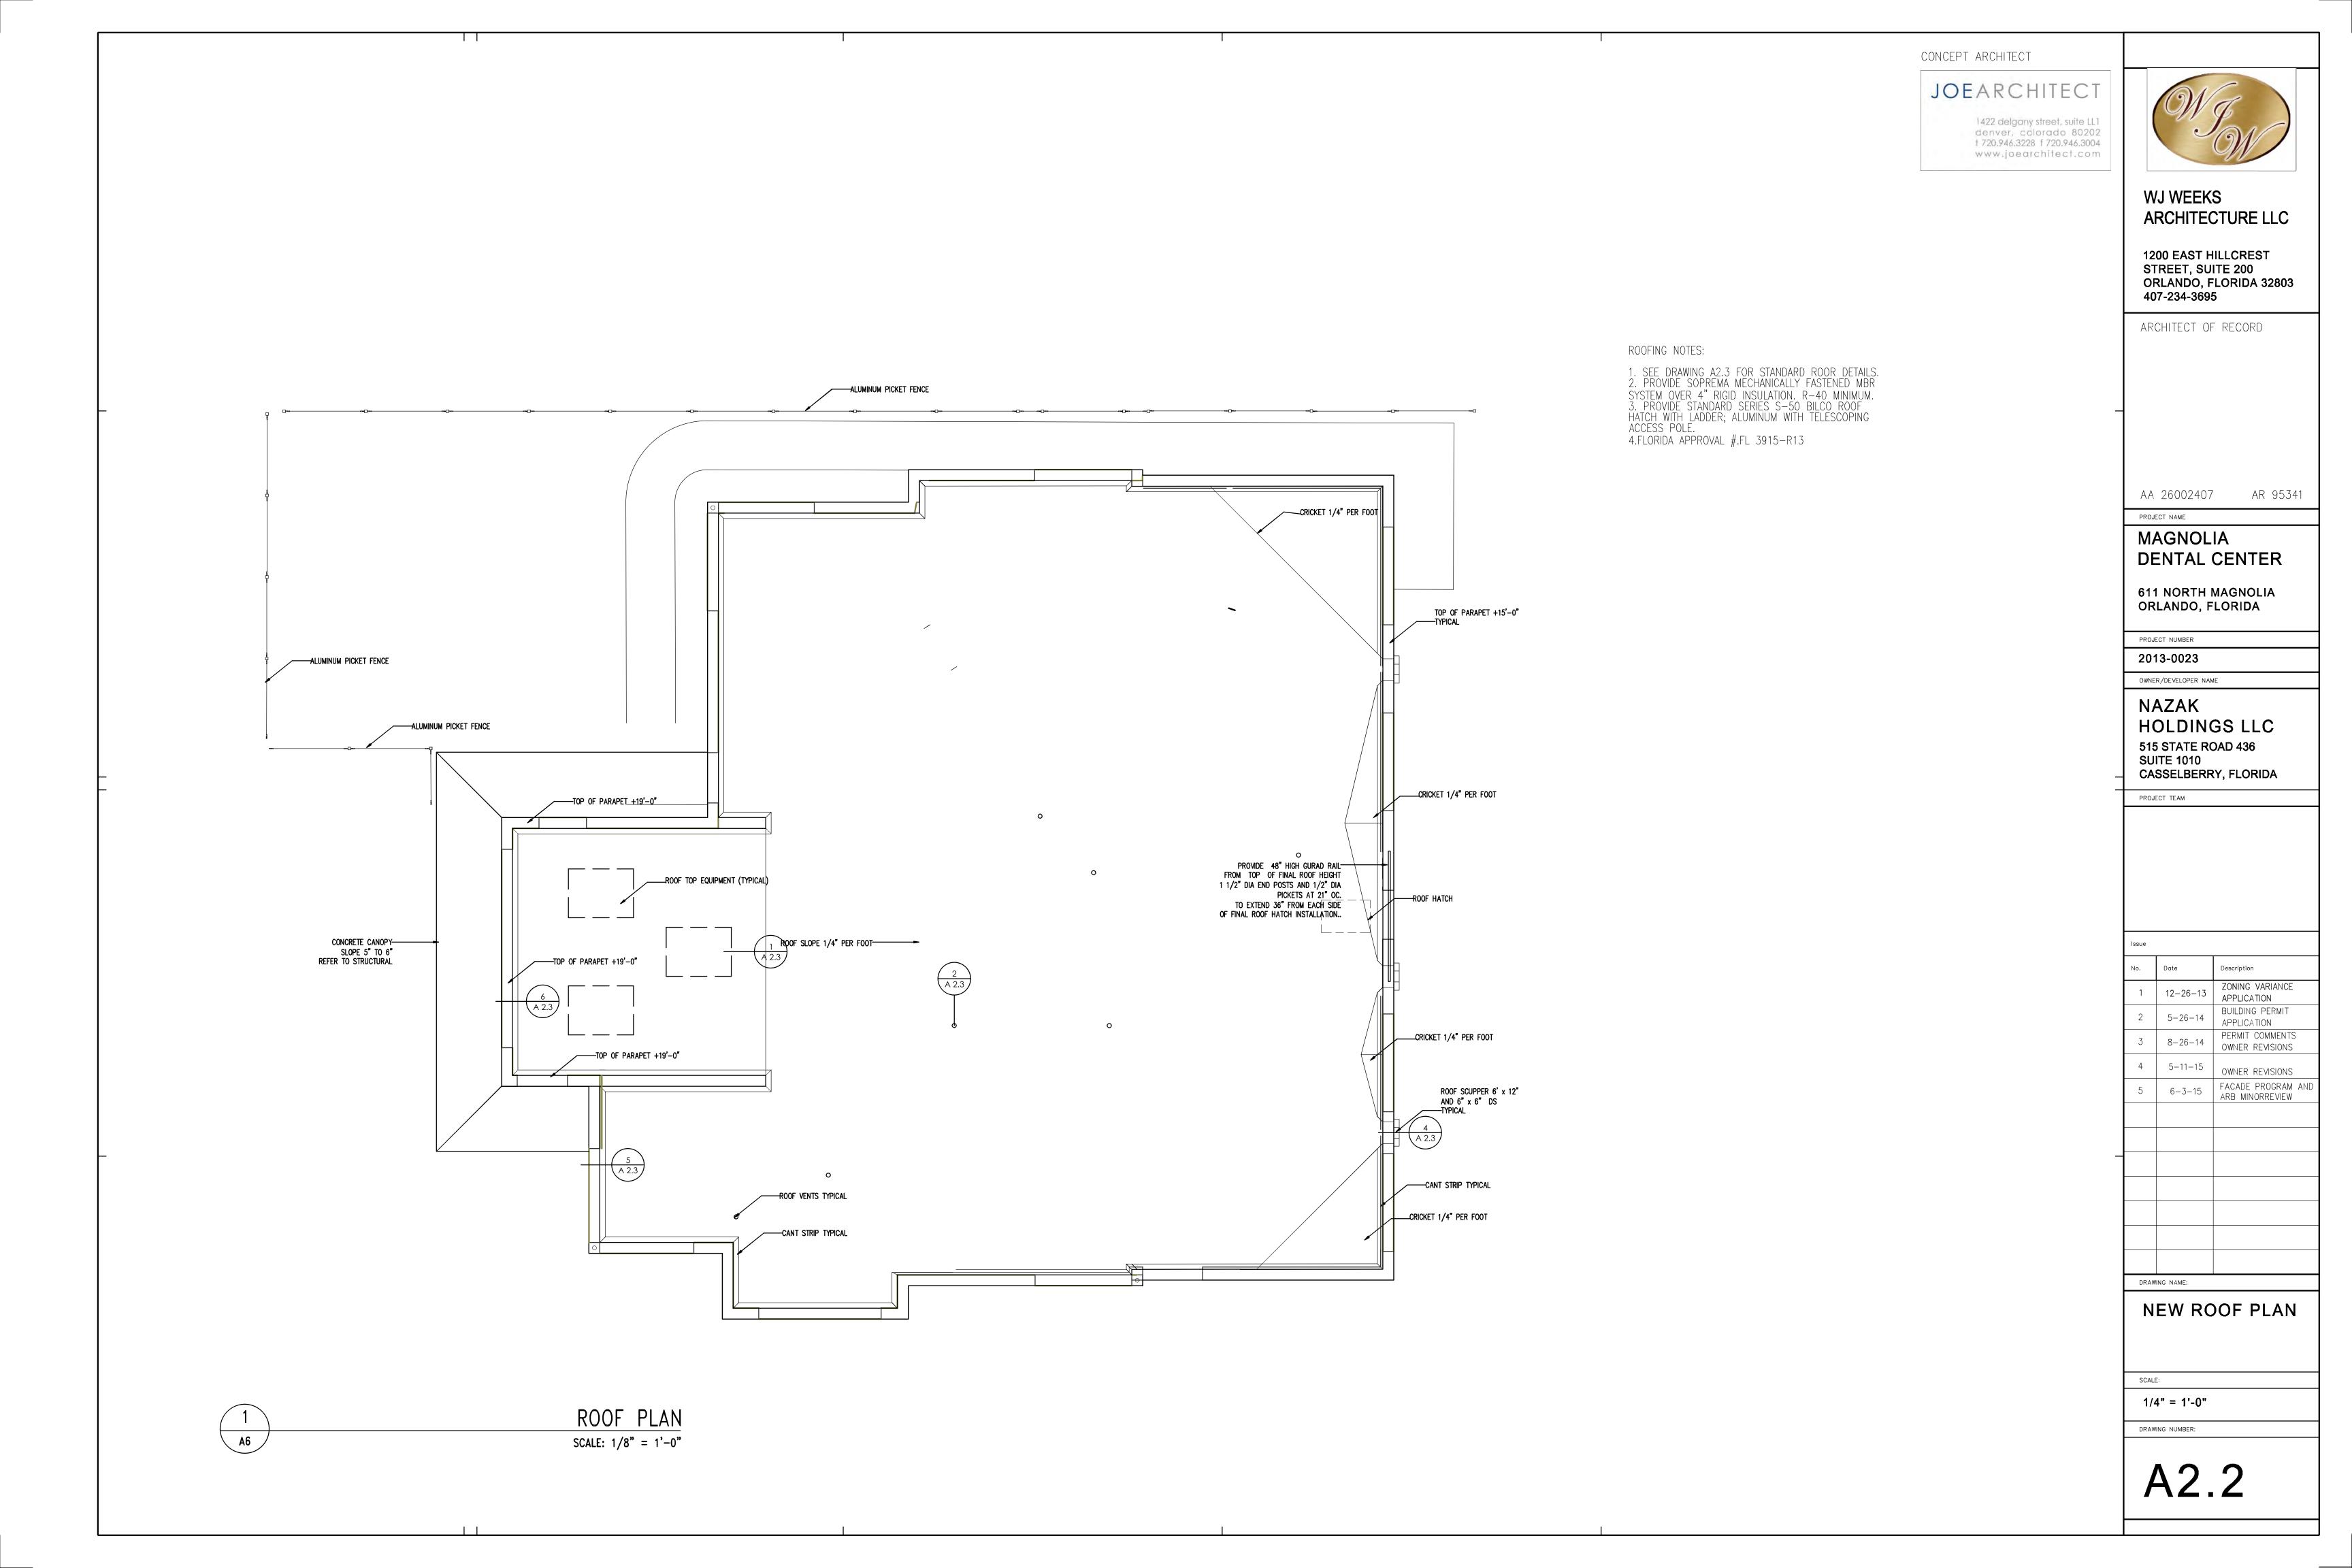


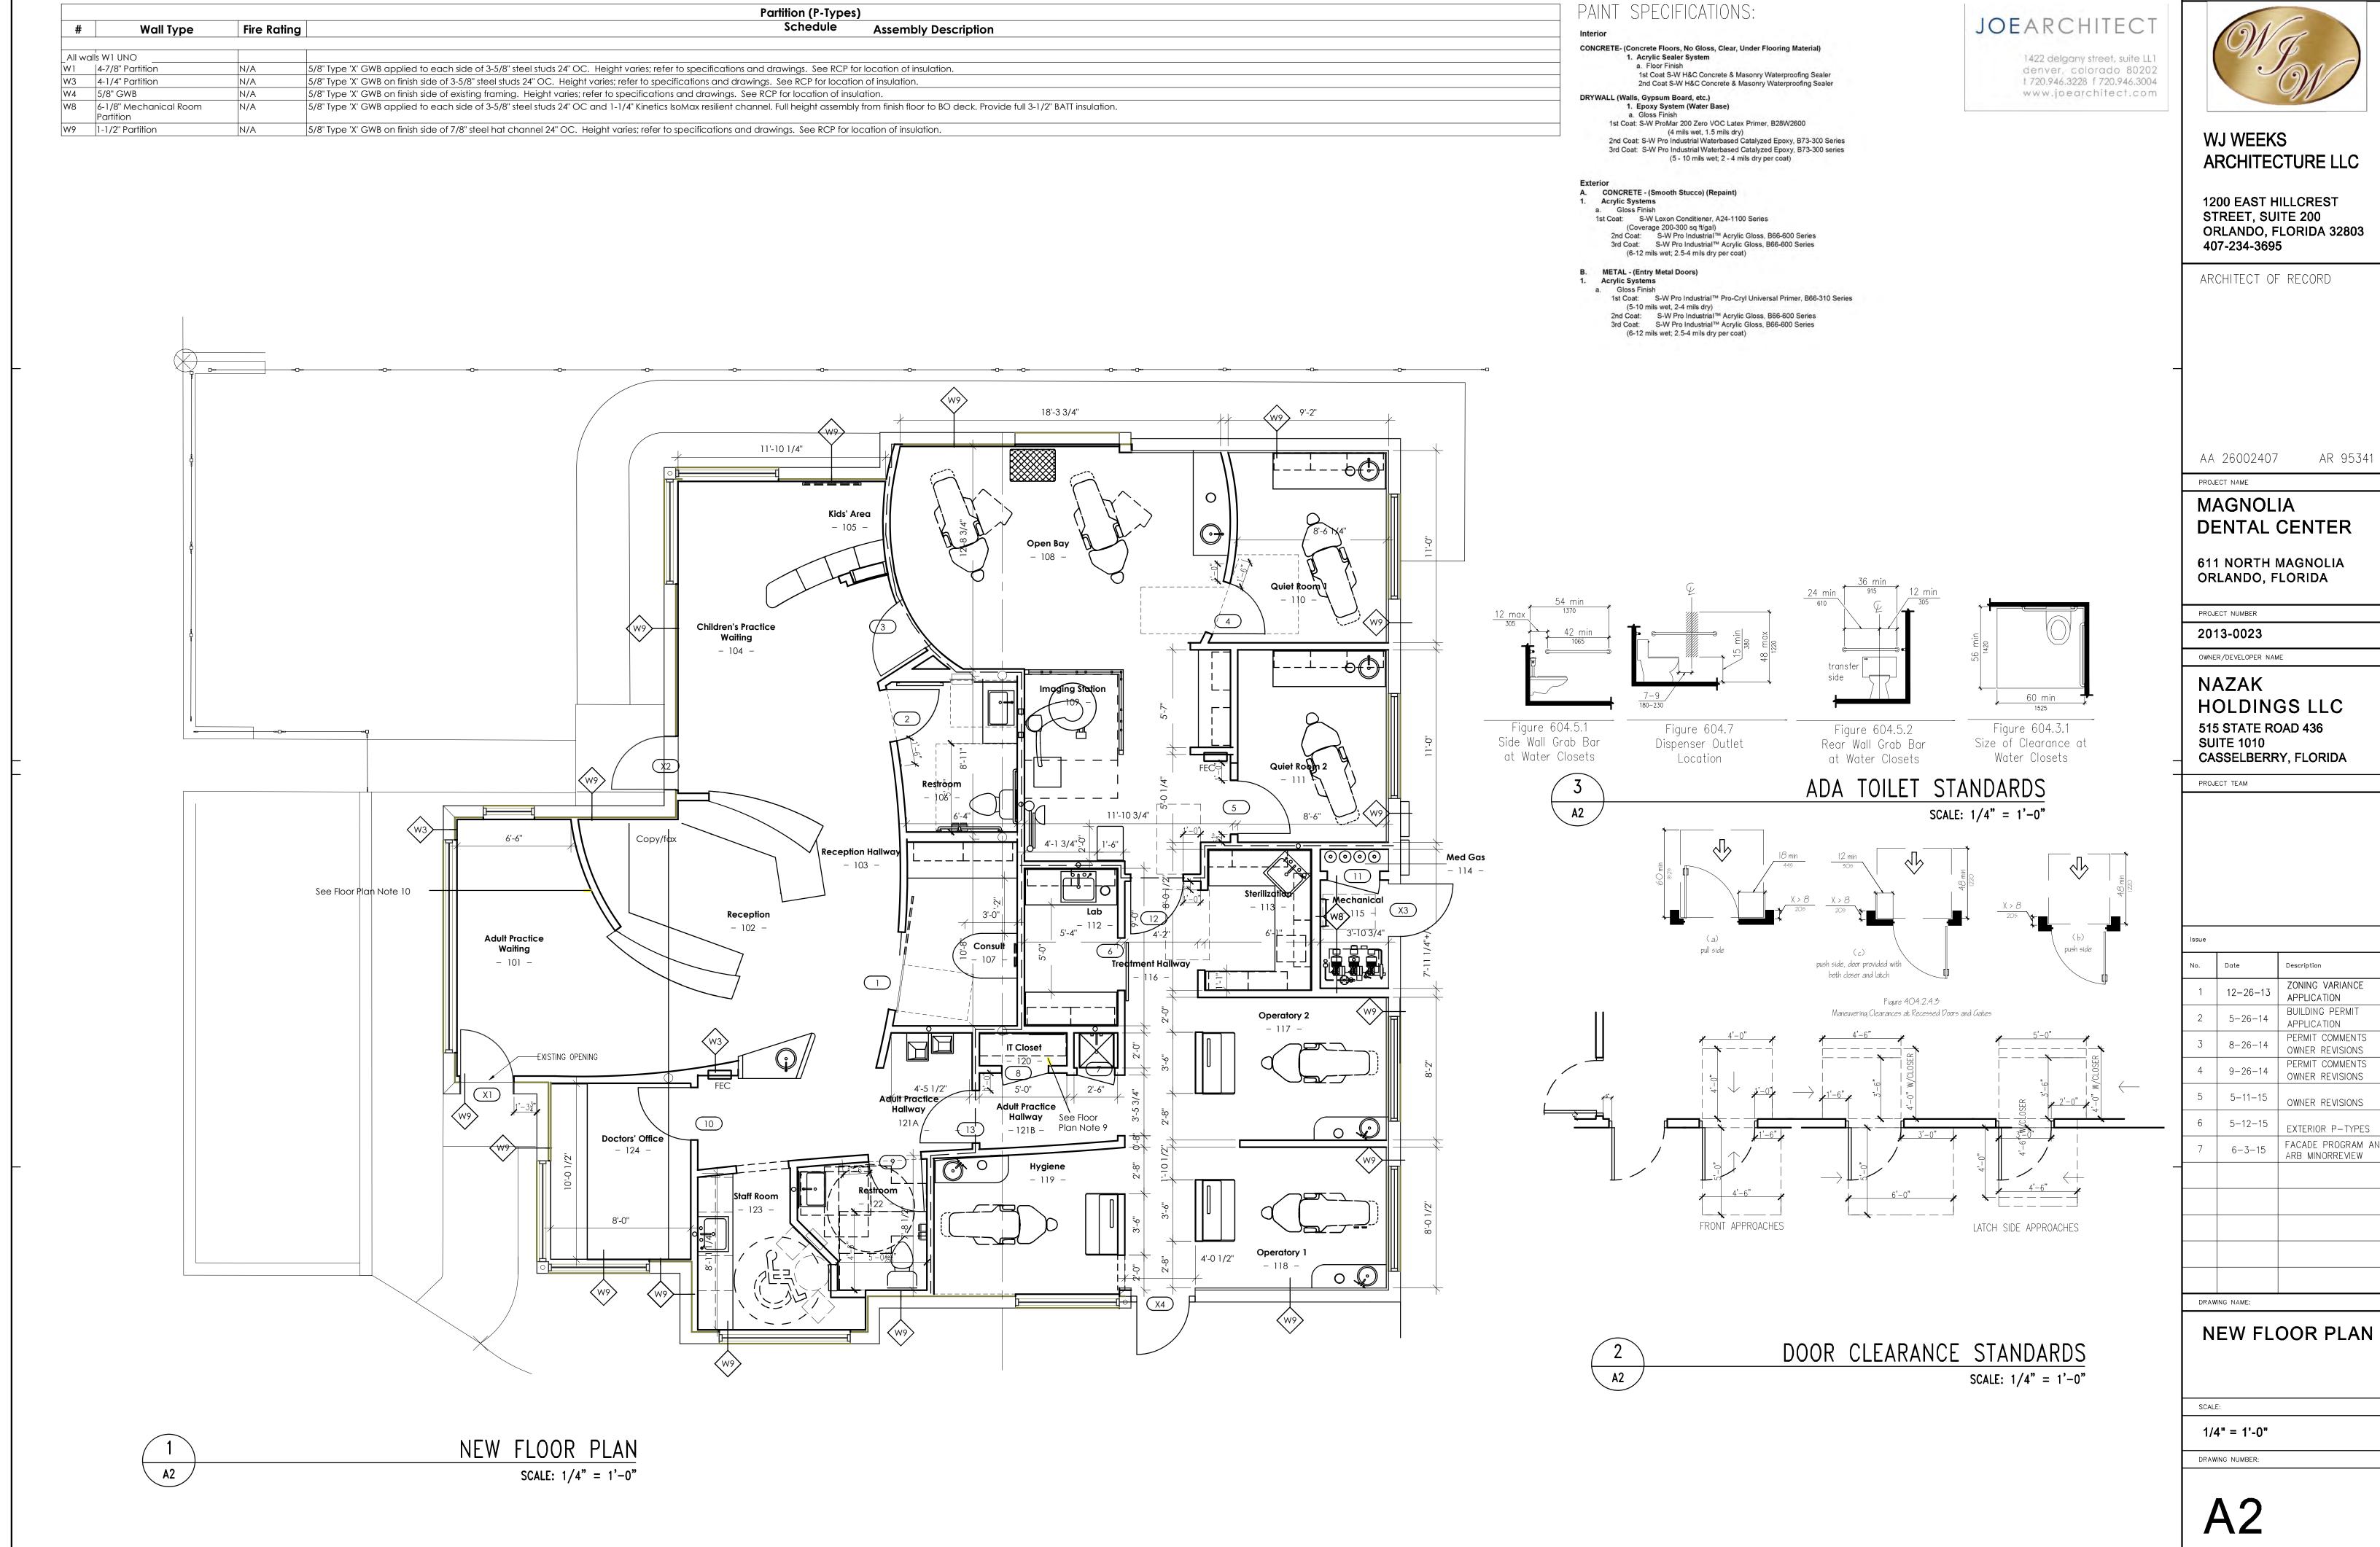



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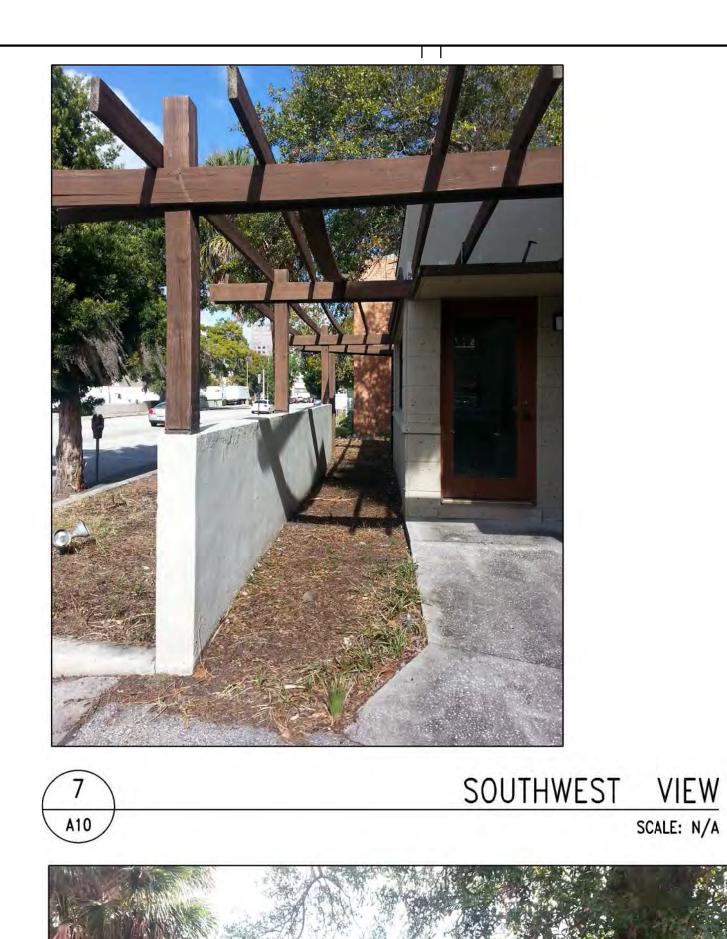
ORLANDO, FLORIDA 32803

1	12-26-13	ZONING VARIANCE APPLICATION
2	5-26-14	BUILDING PERMIT APPLICATION
3	8-26-14	PERMIT COMMENTS OWNER REVISIONS
1	9-26-14	PERMIT COMMENTS OWNER REVISIONS
5	5-11-15	OWNER REVISIONS
5	5-12-15	EXTERIOR P-TYPES
7	6-3-15	FACADE PROGRAM AND ARB MINORREVIEW



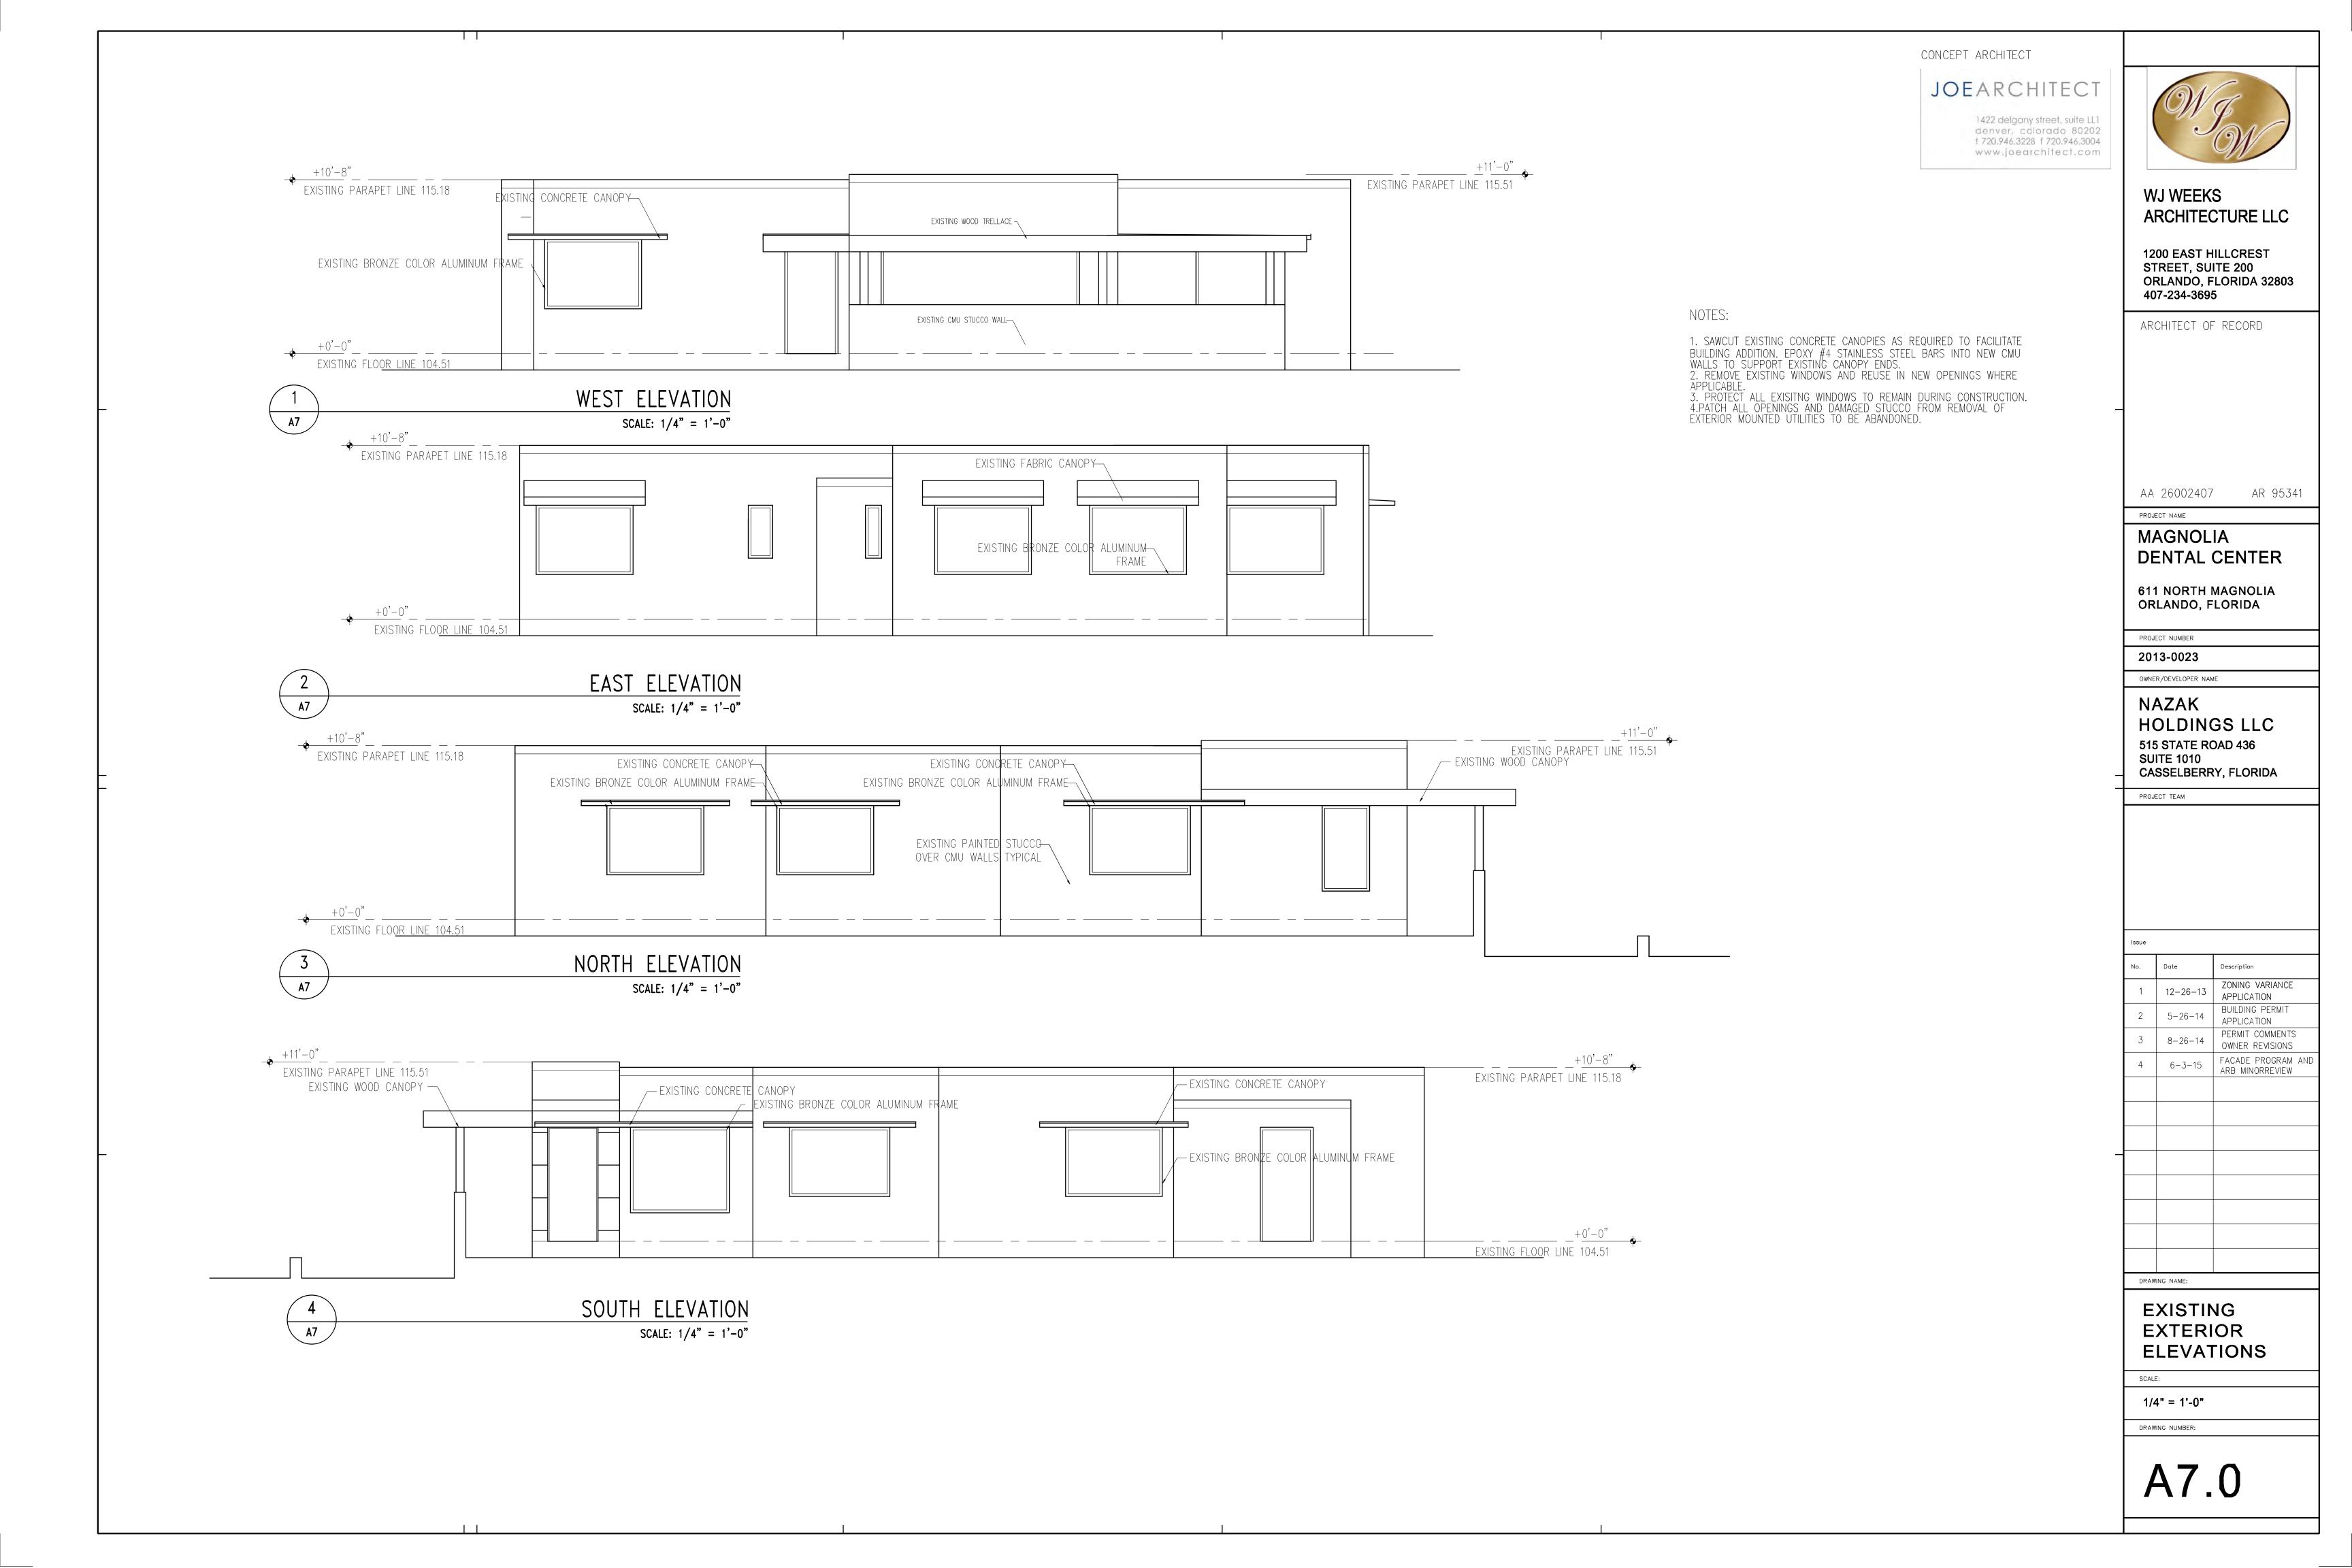

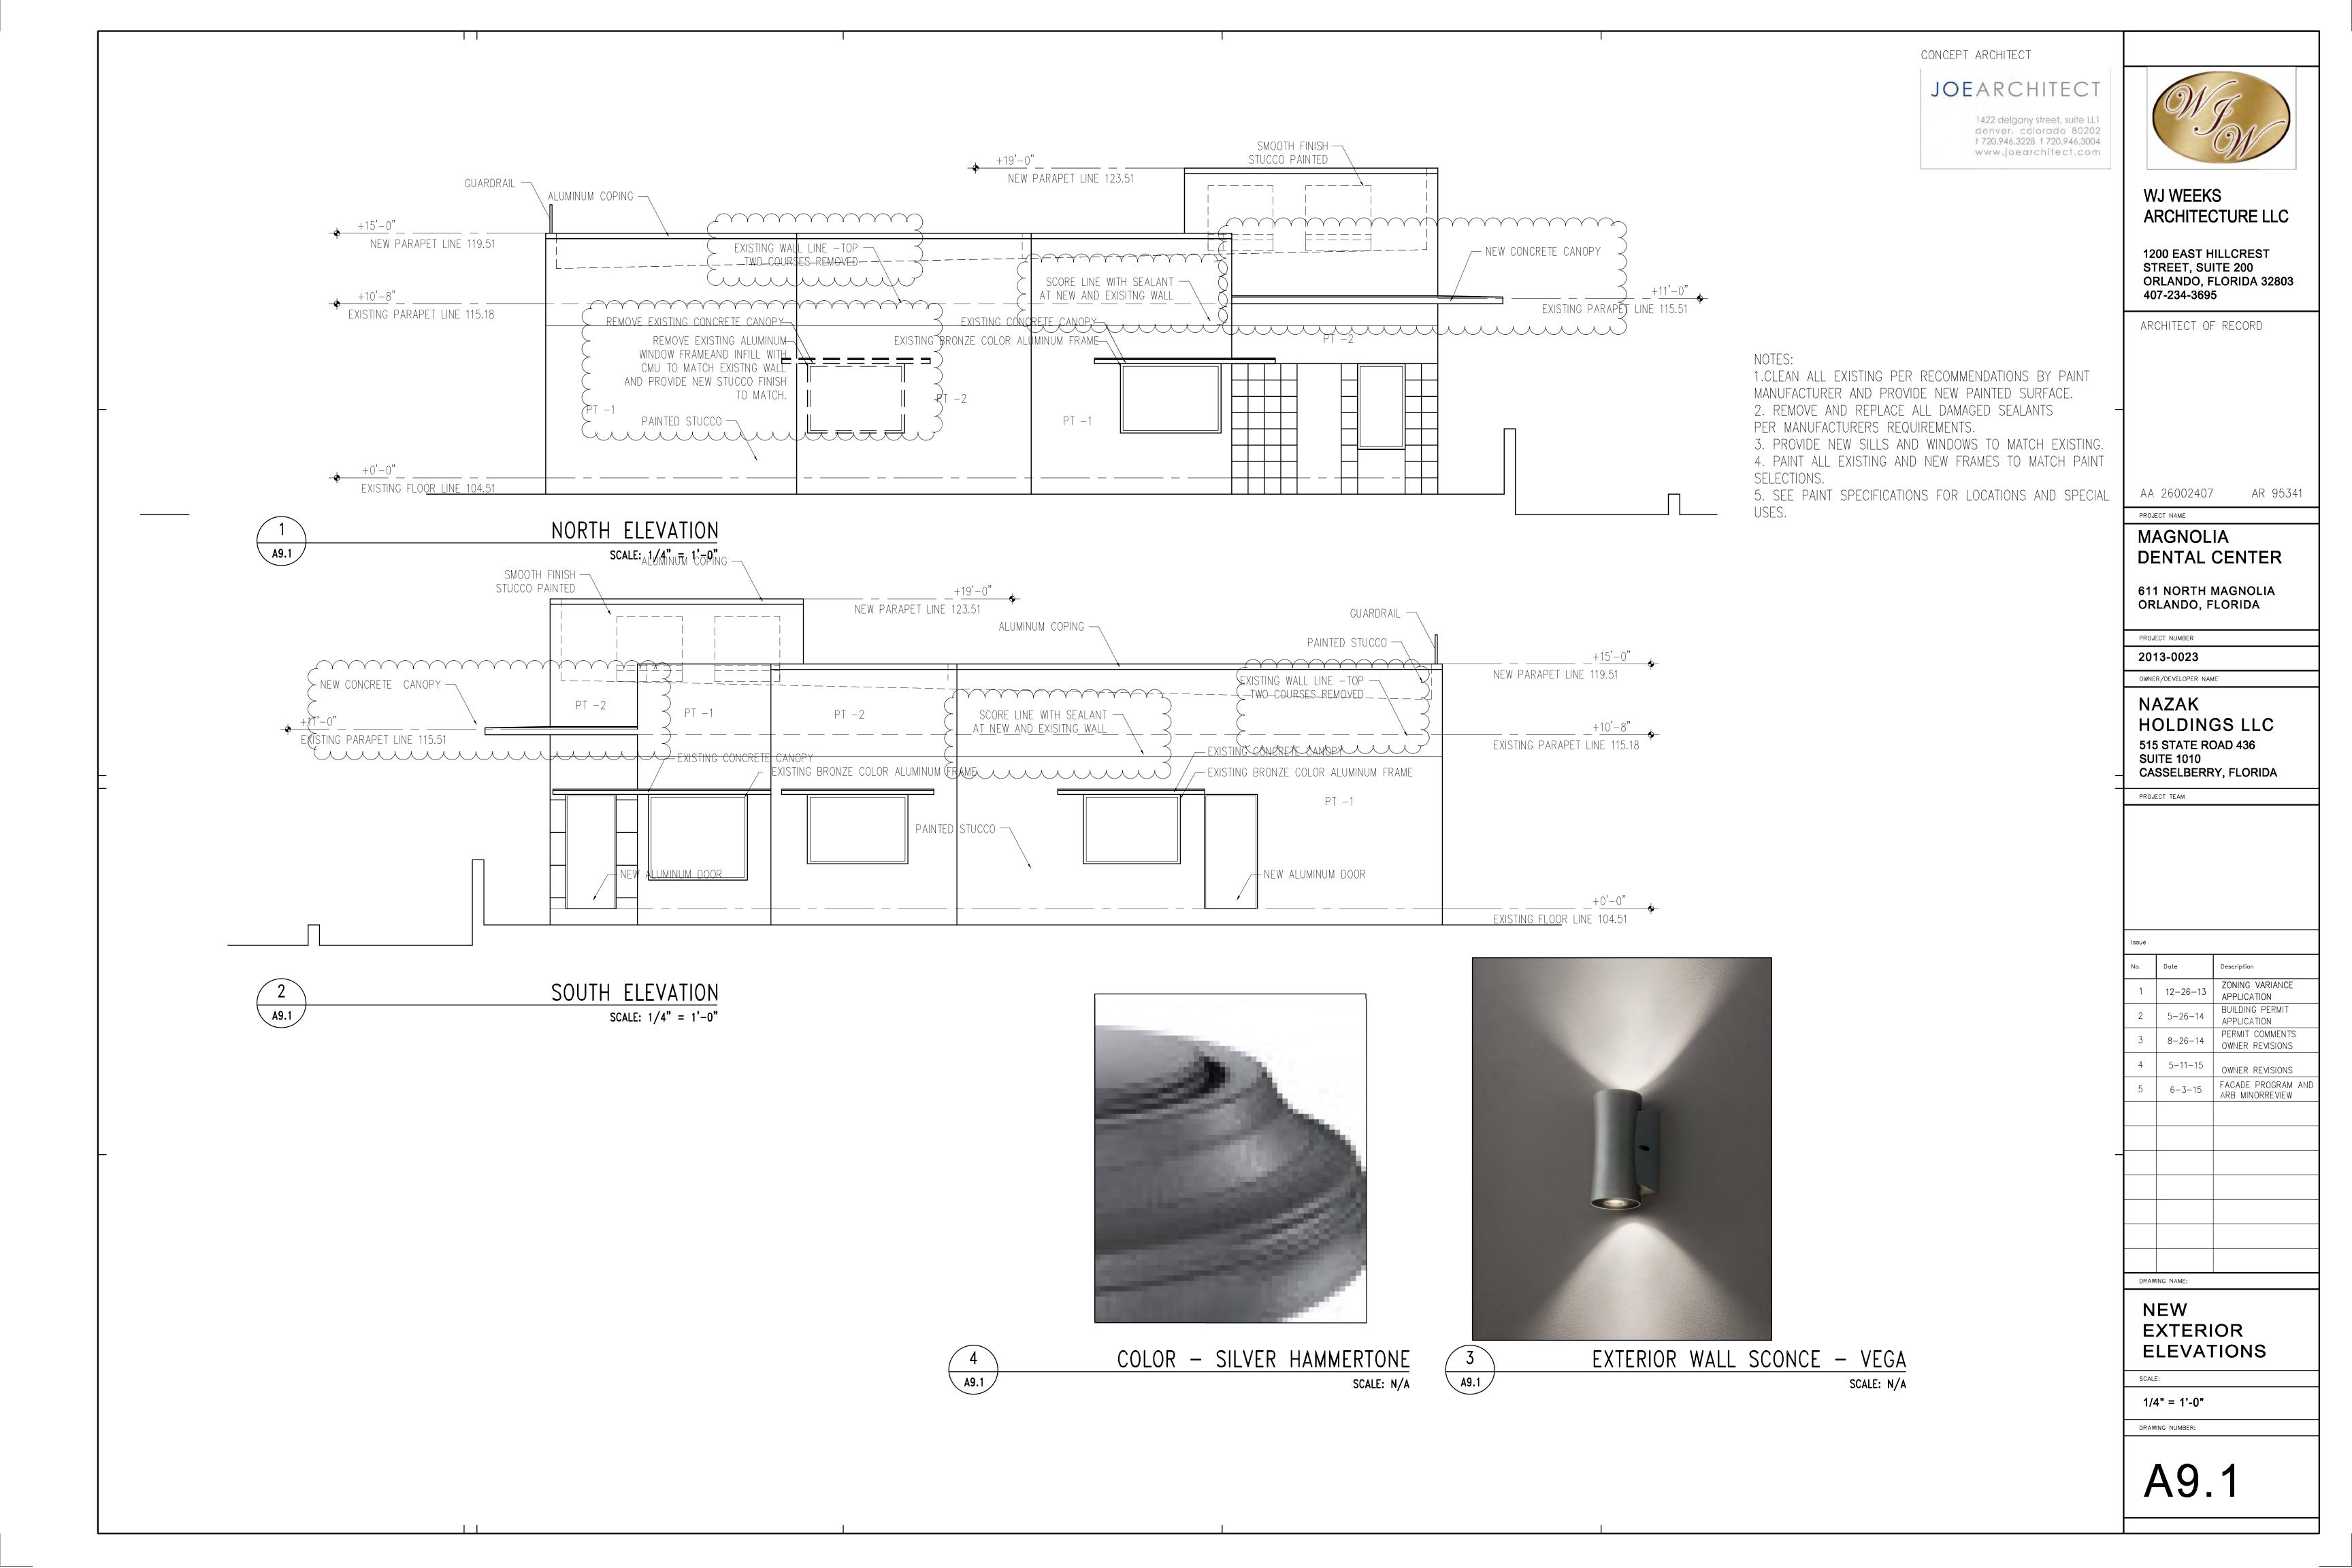

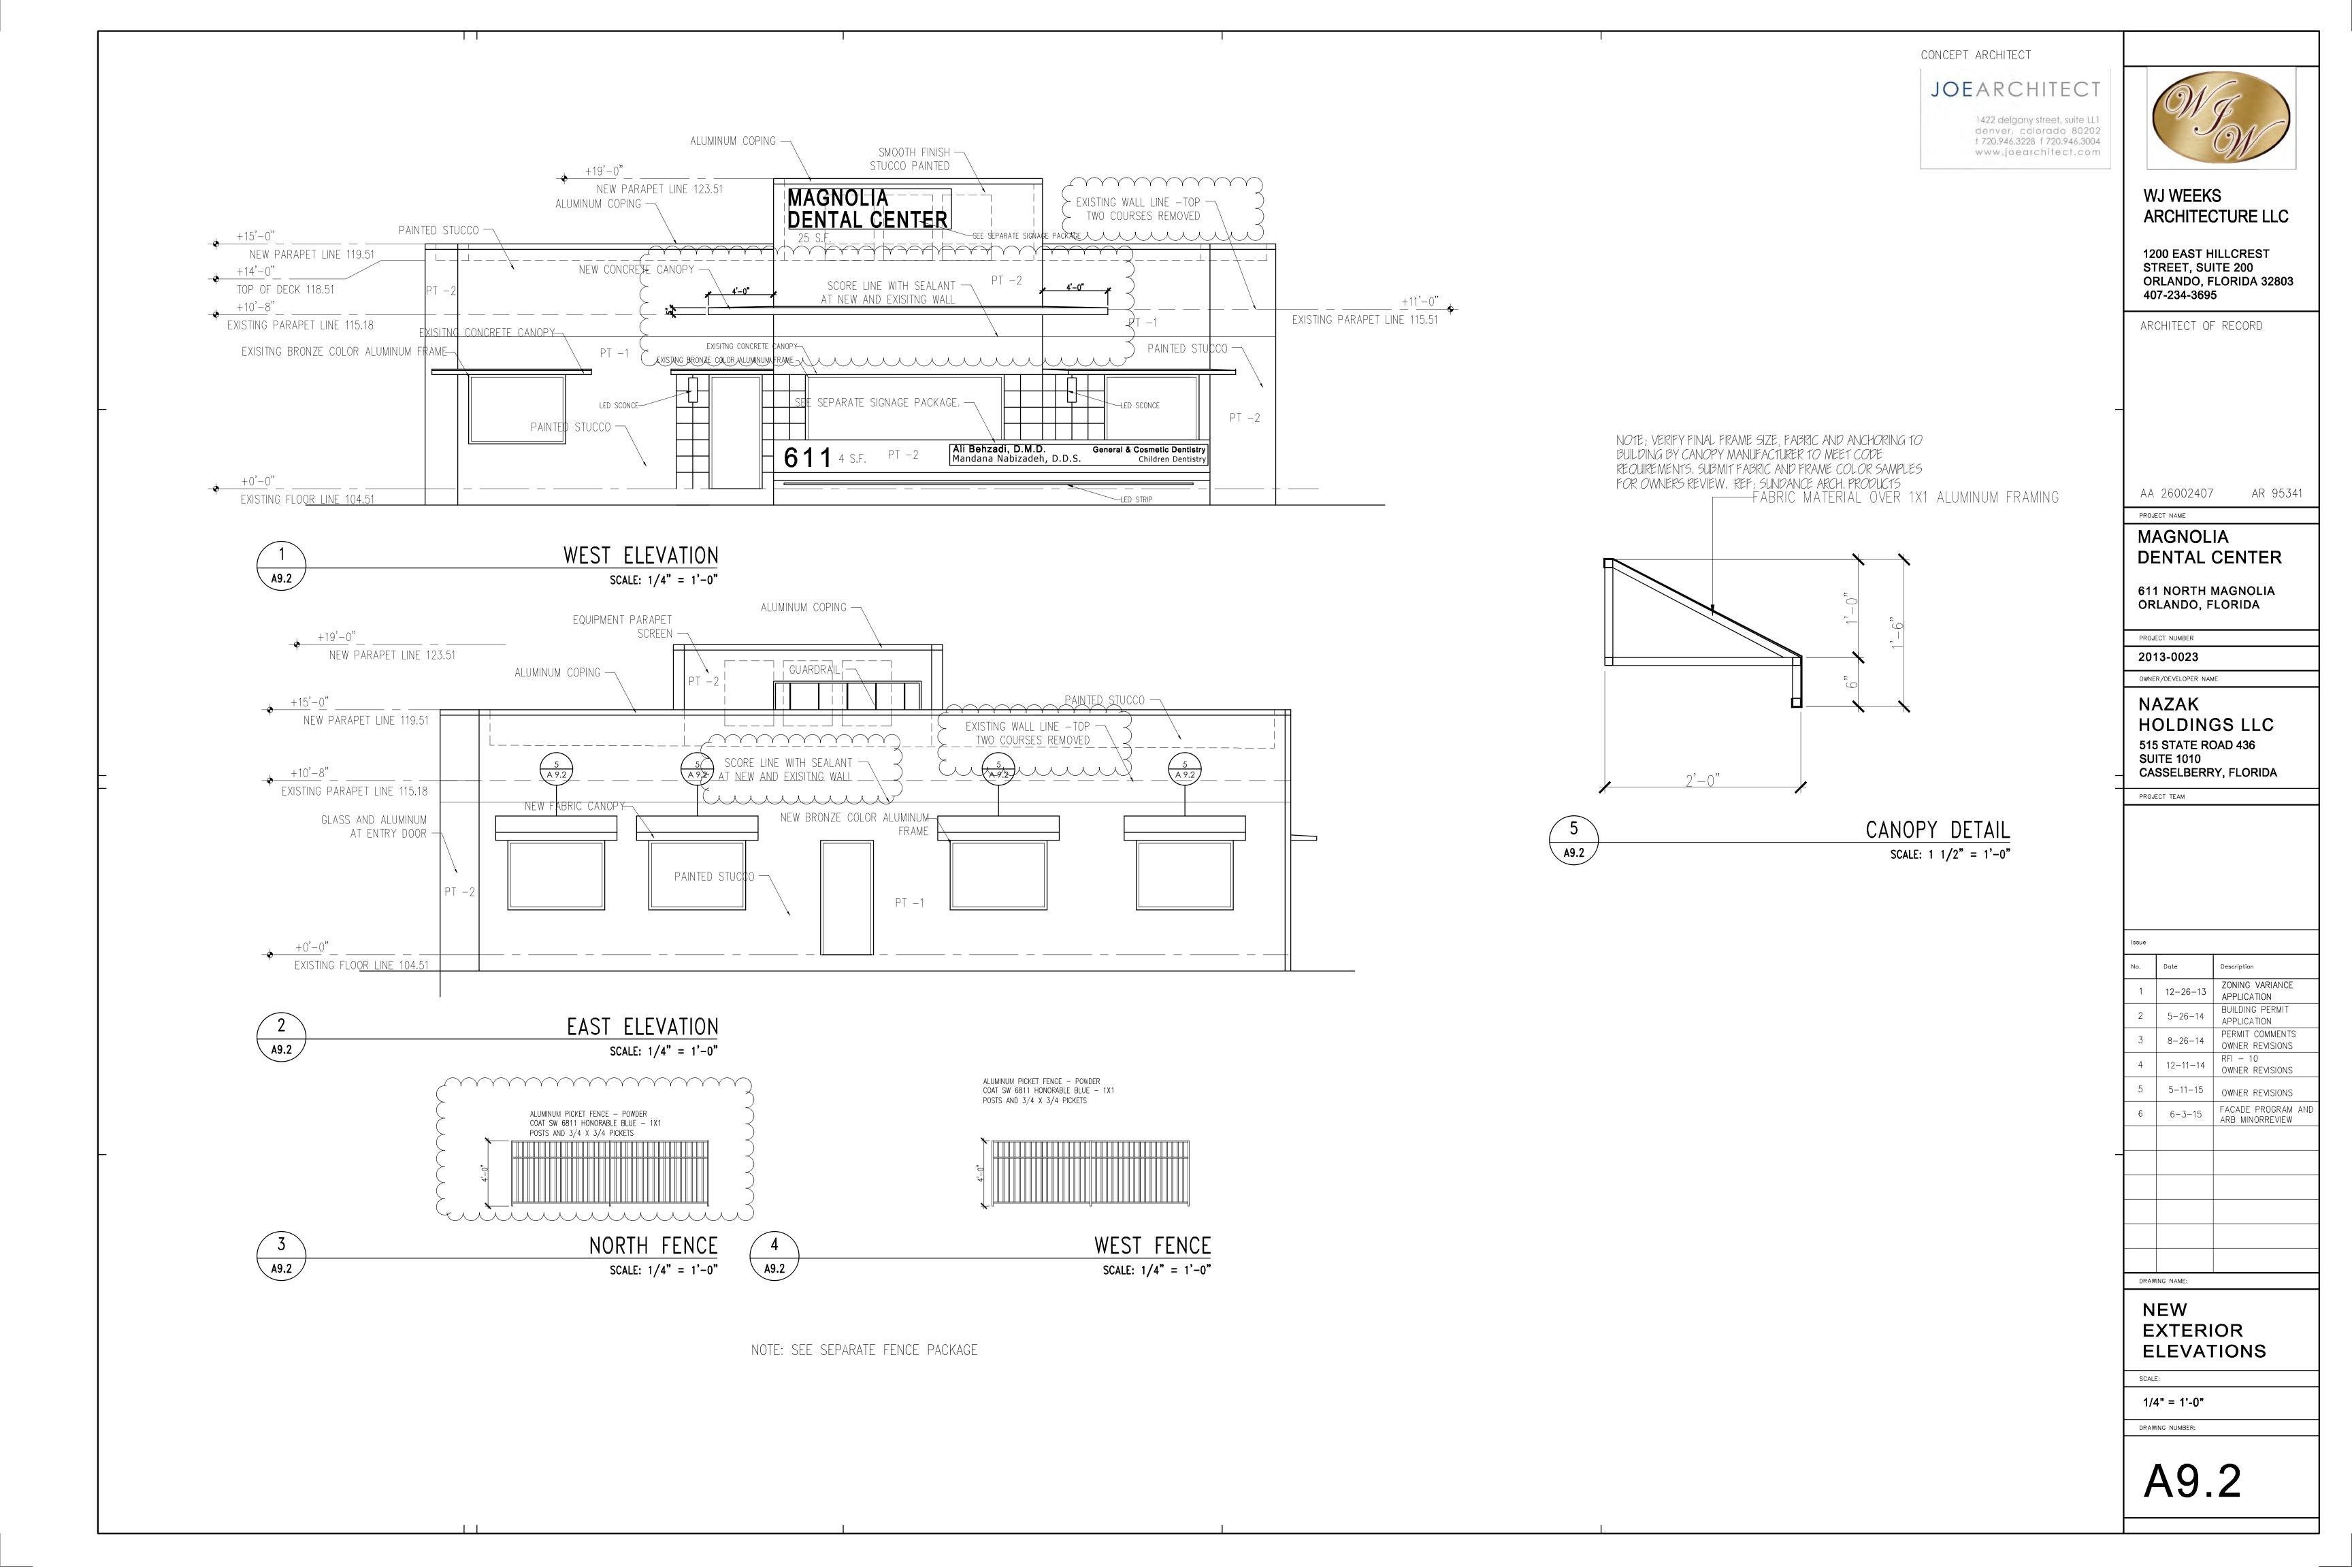







SOUTH WEST

SCALE: N/A

CONCEPT ARCHITECT JOEARCHITECT 1422 delgany street, suite LL1 denver, colorado 80202 † 720.946.3228 f 720.946.3004 www.joearchitect.com

> WJ WEEKS ARCHITECTURE LLC

1200 EAST HILLCREST STREET, SUITE 200 ORLANDO, FLORIDA 32803 407-234-3695

ARCHITECT OF RECORD

AA 26002407

PROJECT NAME MAGNOLIA **DENTAL CENTER**

AR 95341

611 NORTH MAGNOLIA ORLANDO, FLORIDA

PROJECT NUMBER

2013-0023 OWNER/DEVELOPER NAME

NAZAK HOLDINGS LLC 515 STATE ROAD 436 SUITE 1010 CASSELBERRY, FLORIDA

PROJECT TEAM

KEY PLAN SCALE: N/A



SCALE: N/A

NORTHWEST VIEW



A10







NORTH VIEW

SCALE: N/A



SOUTH VIEW SCALE: N/A



SOUTH EAST VIEW SCALE: N/A

ZONING VARIANCE APPLICATION BUILDING PERMIT APPLICATION 2 5-26-14 PERMIT COMMENTS
OWNER REVISIONS FACADE PROGRAM AN ARB MINORREVIEW


> **EXISTING** PHOTOS


DRAWING NAME:

DRAWING NUMBER:

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PHASING NOTES

- 1. CONTRACTOR IS RESPONSIBLE FOR MAINTENANCE FOR TRAFFIC ON-SITE DURING CONSTRUCTION. CONTRACTOR SHALL MAINTAIN VEHICULAR AND PEDESTRIAN ACCESS BY USE OF BARRICADES, TEMPORARY WALKS, FENCING, ETC.
- 2. CONTRACTOR SHALL MAINTAIN UTILITY SERVICE TO EXISTING BUILDING DURING ENTIRE CONSTRUCTION PERIOD. CONTRACTOR SHALL PROVIDE ALL TEMPORARY MEASURES AS REQUIRED.

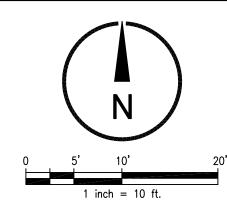DEMOLITION NOTES

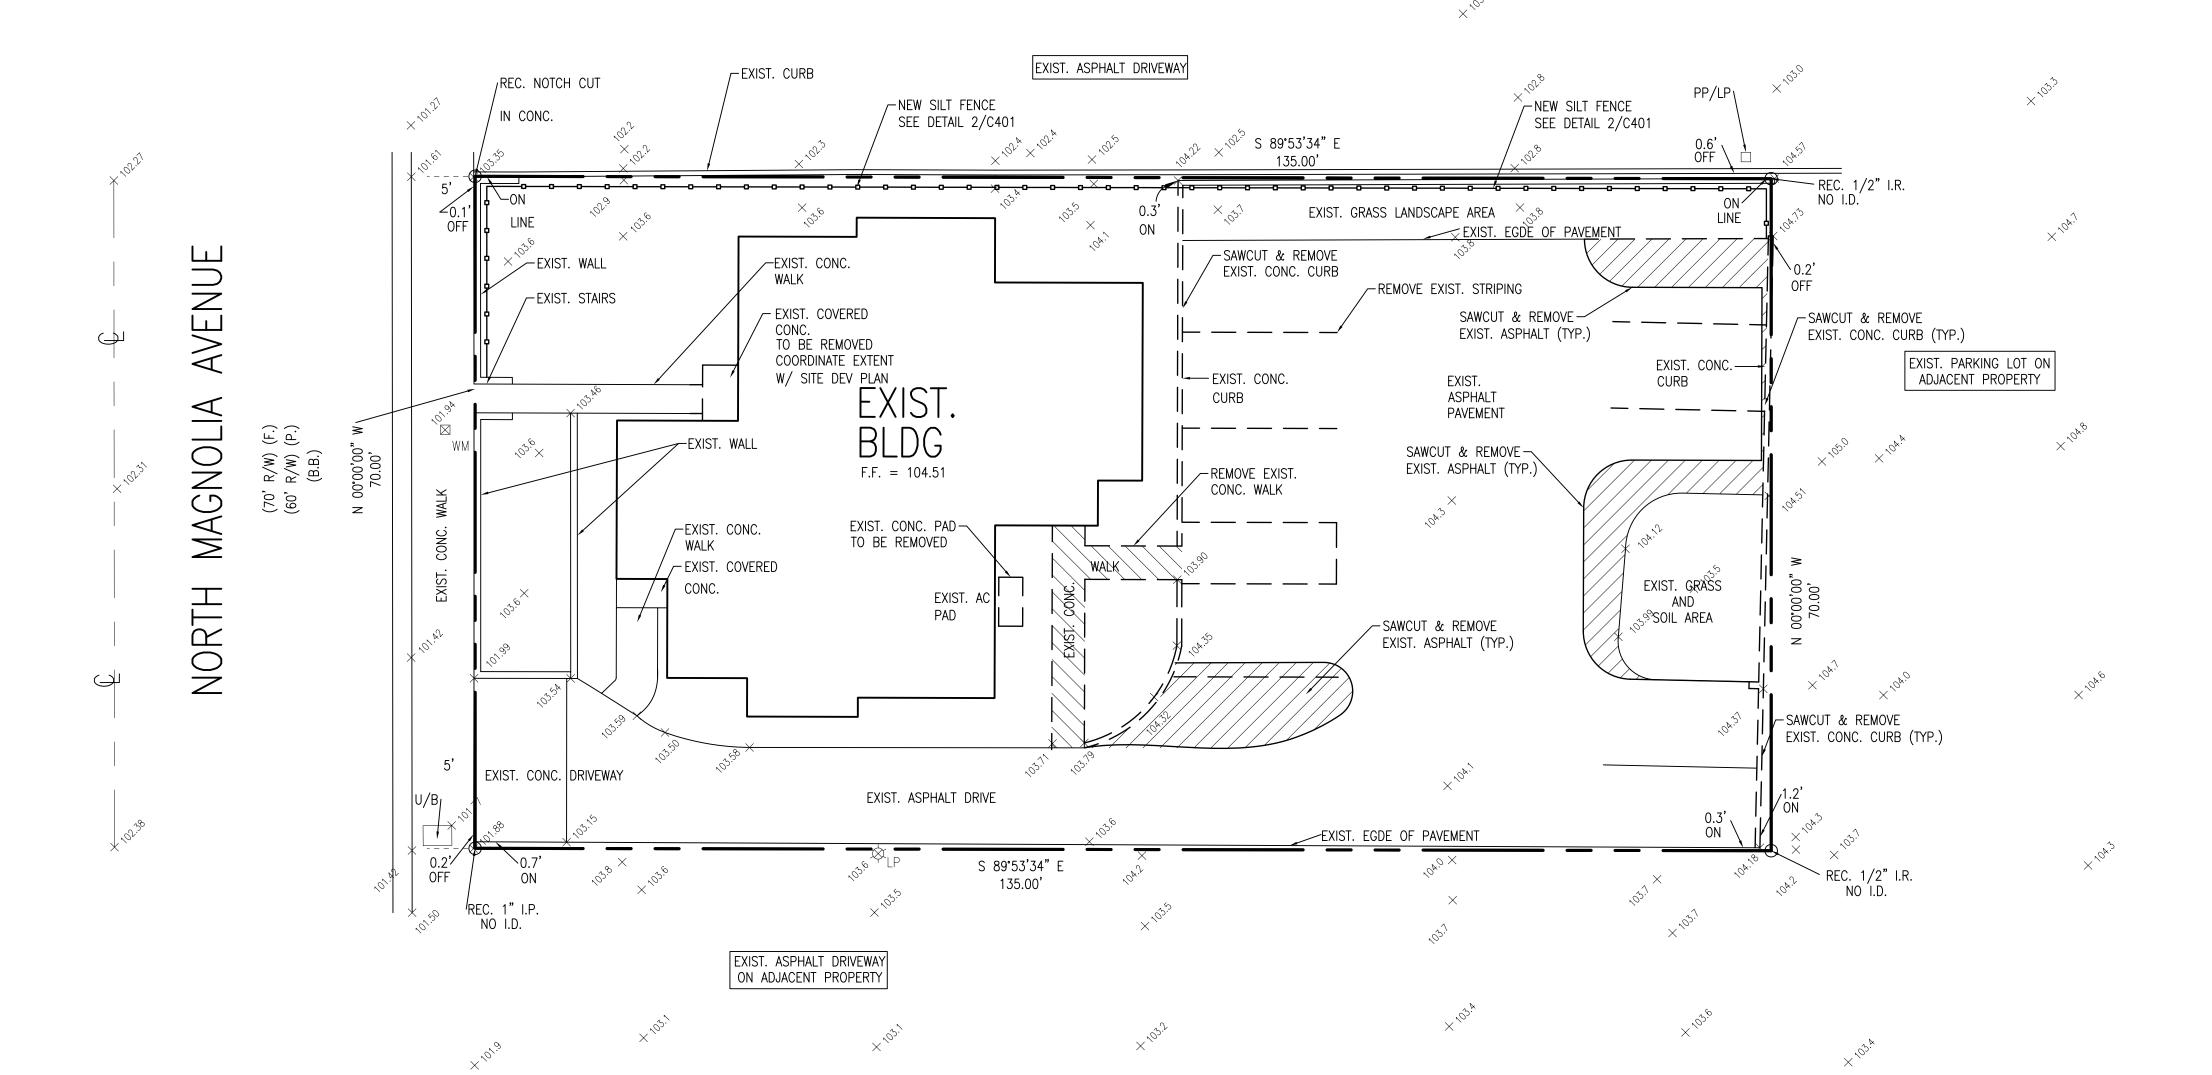- 1. CONTRACTOR SHALL VERIFY LOCATION OF ALL UNDERGROUND UTILITIES AND IMPROVEMENTS PRIOR TO START OF CONSTRUCTION.
- 2. CONTRACTOR SHALL PROTECT THE EDGE OF ALL REMAINING PAVEMENT AND HARDSCAPE.
- OORDINATE WITH ARCHITECTURAL PLANS FOR EXTENT OF ADDITIONAL DEMOLITION AND HARDSCAPE IMPROVEMENTS.
- 4. COORDINATE EXTENT OF CURB AND PAVEMENT REMOVAL AND REPLACEMENT WITH SITE DEVELOPMENT PLAN. 5. INFORMATION CONCERNING EXISTING ABOVE AND BELOW GROUND IMPROVEMENTS DEPICTED ON
- THIS PLAN HAVE BEEN PROVIDED BY TOPOGRAHIC SURVEY PREPARED BY GRUSENMEYER-SCOTT & ASSOC., INC., DATED 3/13/13. CONTRACTOR SHALL VERIFY CONDITIONS ON PROJECT SITE PRIOR TO THE START OF CONSTRUCTION. 6. EXISTING SITE MAY CONTAIN ABOVE AND BELOW GROUND IMPROVEMENTS NOT DEPICTED ON THIS
- PLAN. CONTRACTOR SHALL VERIFY SITE CONDITIONS WITH OWNER'S REPRESENTATIVE AND BE RESPONSIBLE FOR REMOVAL OR RELOCATION OF EXISTING IMPROVEMENTS INTERFERING WITH NEW DEVELOPMENT.

EROSION AND SEDIMENTATION CONTROL NOTES 1. ALL EROSION AND SEDIMENT CONTROL WORK SHALL CONFORM TO CITY OF ORLANDO, ENGINEERING

- STANDARDS MANUAL (ESM), FLORIDA AND ST JOHNS RIVER WATER MANAGEMENT DISTRICT (SFWMD) 2. EROSION AND SEDIMENT CONTROL MEASURES ARE TO BE PLACED PRIOR TO, OR AS THE FIRST STEP IN, CONSTRUCTION.
- 3. SOIL MATERIALS, SHALL BE CONTAINED, AND NOT ALLOWED TO COLLECT ON ANY FF-PERIMETER AREAS OR IN WATERWAYS. THESE INCLUDE BOTH NATURAL AND MAN-MADE OPEN DITCHES, STREAMS, STORM DRAINS, LAKES AND POND.
- 4. DAILY INSPECTIONS SHALL BE MADE BY THE CONTRACTOR TO DETERMINE THE EFFECTIVENESS OF THESE EFFORTS. ANY NECESSARY REMEDIES SHALL BE PERFORMED WITHOUT DELAY.
- 5. ALL MUD. DIRT OR OTHER MATERIALS TRACKED OR SPILLED ONTO EXISTING STATE—COUNTY—CITY OR PRIVATE ROADS AND FACILITIES FROM THIS SITE, DUE TO CONSTRUCTION SHALL BE PROMPTLY REMOVED BY THE CONTRACTOR/BUILDER.
- PERMANENT SOIL EROSION CONTROL MEASURES FOR ALL SLOPES, CHANNELS, DITCHES OR ANY DISTURBED LAND AREAS SHALL BE COMPLETED WITHIN (15) FIFTEEN CALENDAR DAYS AFTER FINAL GRADING. WHEN IT IS NOT POSSIBLE TO PERMANENTLY PROTECT A DISTURBED AREA IMMEDIATELY AFTER GRADING OPERATIONS, TEMPORARY EROSION CONTROL MEASURES SHALL BE INSTALLED. ALL TEMPORARY PROTECTION SHALL BE MAINTAINED UNTIL PERMANENT MEASURES ARE IN PLACE AND ESTABLISHED. A CERTIFICATE OF COMPLIANCE WILL NOT BE ISSUED UNTIL THE ABOVE REQUIREMENTS HAVE BEEN MET.
- COORDINATE LOCATION OF SILT FENCE WITH GRADING PLAN AND EARTHWORK LIMITS. SILT FENCE SHOWN IS THE MINIMUM EROSION PROTECTION MEASURES TO BE CONSTRUCTED. ADDITIONAL EROSION CONTROL MEASURES MUST BE PLACED AS NEEDED, DEPENDENT ON ACTUAL SITE CONDITIONS AND CONSTRUCTION OPERATION.

Seal: Majid Kalaghchi P.E. 41046

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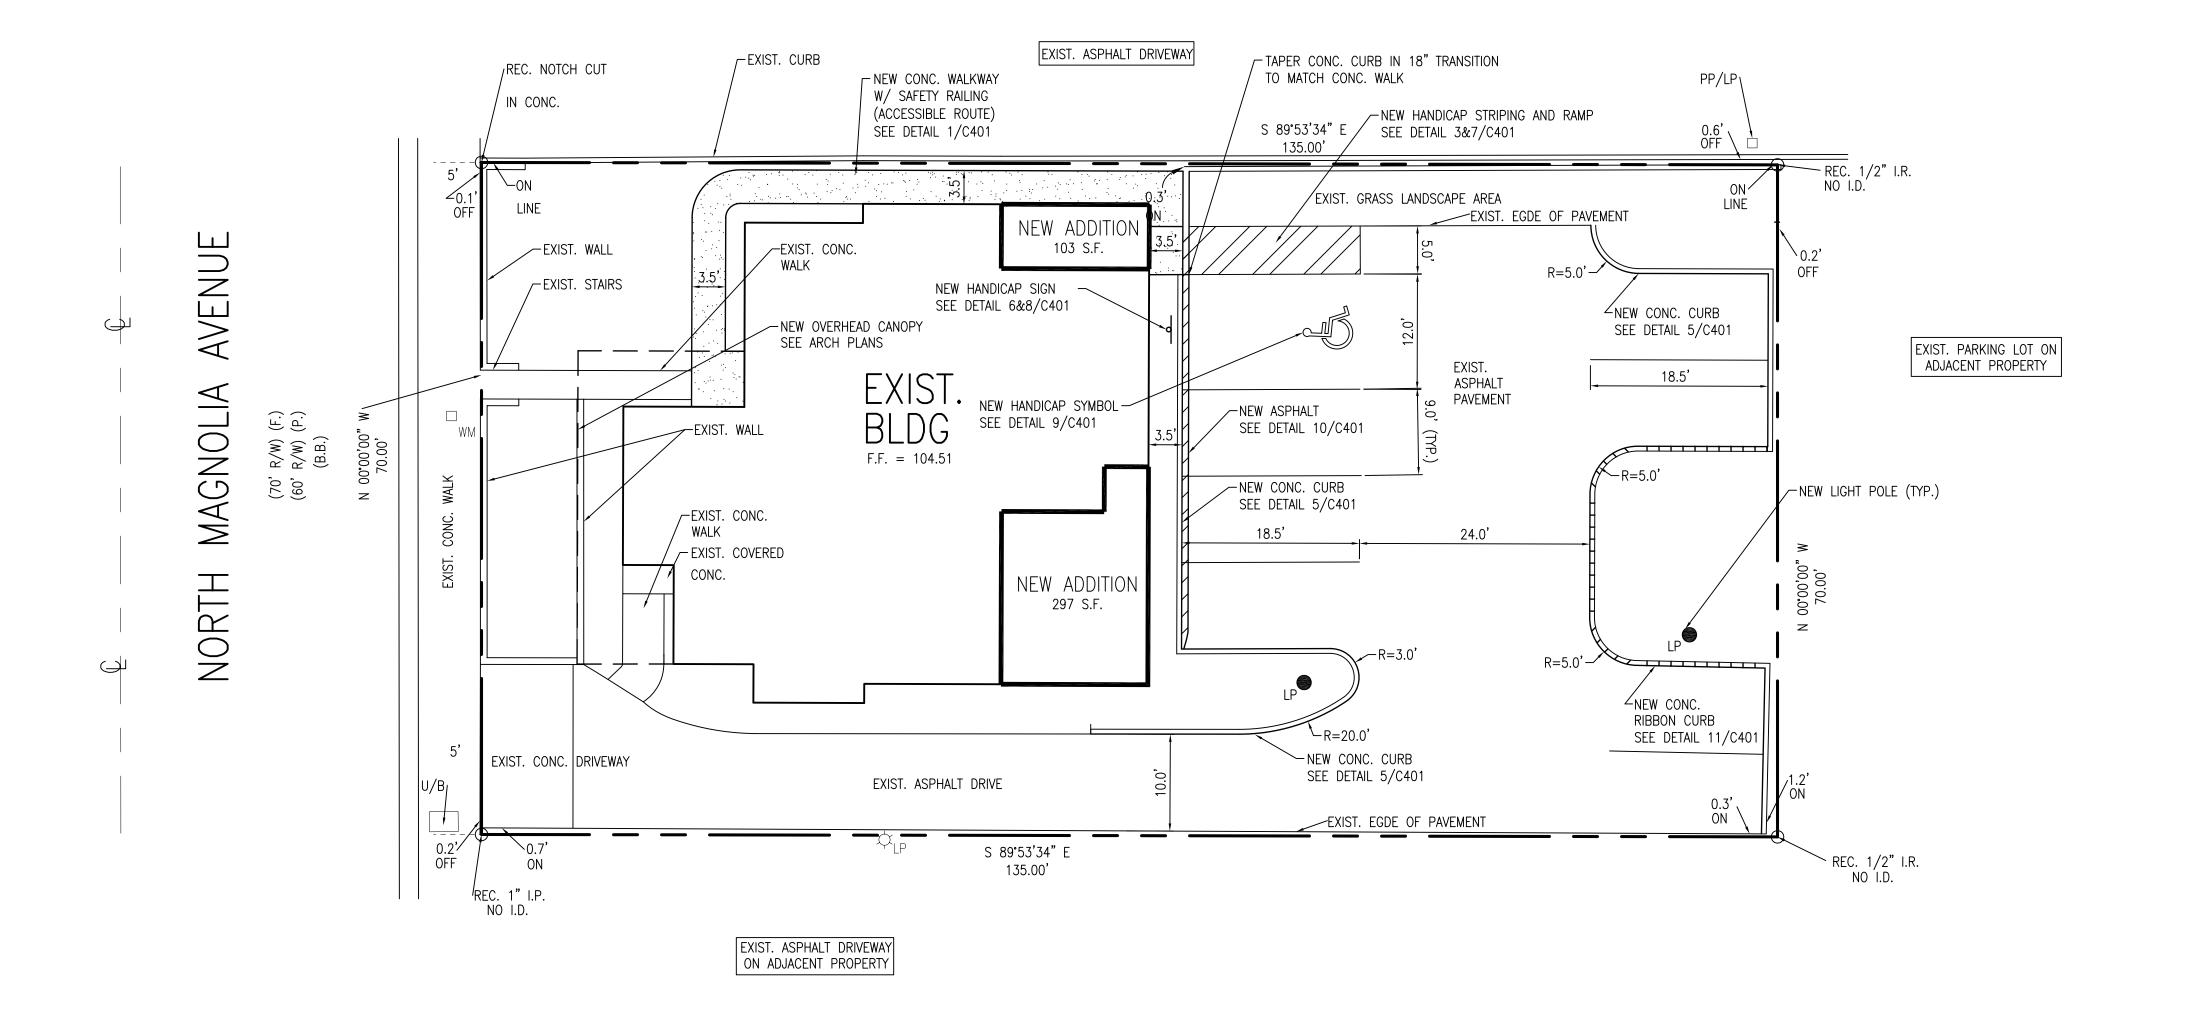
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	-24-14 d Purpose 1352

OVERALL EXISTING SITE PLAN

SCALE: 1" = 10'


EXIST. SITE DATA TOTAL SITE AREA = 9,450 S.F. = 0.217 AC.EXISTING ZONING = 0-3/TEXISTING LAND USE = VACANT OFFICE (1,985 S.F.) = 0.40 MINIMUM, 1.0 MAXIMUM F.A.R. REQUIREMENT = 7,500 S.F. (9,450 S.F. EXIST.) MIN. LOT AREA REQUIREMENT MIN. LOT WIDTH REQUIREMENT = 75' (70' EXIST.) PRINCIPAL BLDG SETBACK REQUIREMENT FRONT (MAGNOLIA AVENUE) = 0' MINIMUM, 10' MAXIMUM (14.7' EXIST.) = 0' OR 3' MINIMUM, 25' MAXIMUM (NORTH 4.2', SOUTH 13.7' EXIST.) SIDE (NORTH/SOUTH) REAR (EAST) = 20' MINIMUM (65.5' EXIST.) = 0.90 (0.71 EXIST.)MAXIMUM ISR MAXIMUM BUILDING HEIGHT = 75' EXIST. BLDG = 1,985 S.F. EXIST. PAVEMENT = 4,706 S.F.EXIST. IMPERVIOUS AREA = 6,691 S.F. = 0.154 AC. = 70.8%EXIST. PERVIOUS AREA = 2,759 S.F. = 0.063 AC. = 29.2%

<u>LEGEND</u>		
	EXIST.	TO BE REMOVED
ASPHALT PAVEMENT		
CONCRETE WALK		
CONCRETE CURB		====
SIGN	-0-	
CHAIN LINK FENCE	—x——x——x—	
WATER LINE	——— W ———	
SANITARY SEWER LINE	SS	— —ss— —
STORM DRAIN LINE	SD	— SD— —
POWER POLE	گ bb	
LIGHT POLE	\mathbf{z}^{LP}	
FIRE HYDRANT	${f Q}^{\sf FH}$	
SANITARY SEWER MANHOLE	0	\oslash
STORM DRAIN INLET		



SITE DEVELOPMENT PLAN

SCALE: 1" = 10'

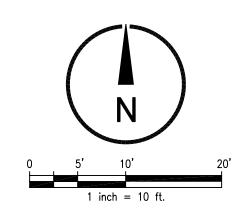

EXIST. SITE DATA

TOTAL SITE AREA = 9,450 S.F. = 0.217 AC. EXISTING ZONING = 0-3/TPRINCIPAL BLDG SETBACK REQUIREMENT

FRONT (MAGNOLIA AVENUE) = 0' MINIMUM, 10' MAXIMUM (14.7' EXIST.)

SIDE (NORTH/SOUTH) = 0' OR 3' MINIMUM, 25' MAXIMUM (NORTH 4.2', SOUTH 13.7' EXIST.)

REAR (EAST) = 20' MINIMUM (65.5' EXIST.)
EXIST. BLDG = 1,985 S.F.

EXIST. PAVEMENT = 4,706 S.F.

EXIST. IMPERVIOUS AREA = 6,691 S.F. = 0.154 AC. = 70.8%

EXIST. PERVIOUS AREA = 2,759 S.F. = 0.063 AC. = 29.2%

NEW SITE DATA

RENOVATION OF EXISTING BUILDING FOR DENTAL OFFICE EXISTING BLDG = 1,985 S.F. NEW ADDITION = 400 S.F. TOTAL PROPOSED BLDG = 2,385 S.F. F.A.R. = 0.25= 4,706 S.F. EXISTING PAVEMENT PAVEMENT REMOVED = 551 S.F. PAVEMENT ADDED = 278 S.F. = 6,818 S.F. = 0.157 = 72.4%* TOTAL IMPERVIOUS AREA

TOTAL IMPERVIOUS AREA = 6,818 S.F. = 0.157 = 72.4%* TOTAL PERVIOUS AREA = 2,632 S.F. = 0.06 = 27.6%

*273 S.F. OF PAVEMENT HAS BEEN REMOVED AND 400 S.F. OF BLDG HAS BEEN ADDED *NET INCREASE IN IMPERVIOUS AREA IS 127 SF

PARKING CALCULATION

PARKING REQUIREMENT (DENTAL OFFICE): MIN = 2.8/1000, MAX = 4/1000
PARKING REQUIRED = 7 SPACES
PARKING PROVIDED = 8 SPACES (7 REGULAR + 1 DISABLED SPACES)

GENERAL NOTES

1. TRAFFIC MARKINGS NOTES:

- A. ALL DRIVEWAYS EXITING ONTO ANY PUBLIC OR PRIVATE STREET MUST HAVE A TRAFFIC CONTROL DEVICE (30" STOP SIGN MOUNTED 7' ABOVE THE PEDESTRIAN VEHICLE TRAVEL WAY (MEASURED FROM BOTTOM OF SIGN) AND THROUGHOUT THE SITE AS NECESSARY FOR SAFETY.
- B. ALL SIGN INSTALLATIONS SHALL COMPLY WITH SIZE, LOCATION AND HEIGHT (7') AS OUTLINED IN THE "MUTCD."
- C. PAVEMENT MARKINGS GENERAL PRINCIPLES (SECTION 3A–5):

 1. PARKING LOT PAVEMENT MARKINGS SHALL BE WHITE PAINTED

 (DIRECTIONAL ARROWS, STOP BARS, LINES DESIGNATING PARKING
- SPACES AND HANDICAPPED PARKING SYMBOLS).

 D. ALL HANDICAPPED PARKING SPACES MUST BE LEGALLY SIGNED WITH ONE REGULATION HANDICAP SIGN AND ONE WHITE PAVEMENT MARKING SYMBOL PER SPACE.
- E. A 24" STOP BAR SHALL BE PROVIDED AT ALL POINTS OF EGRESS IN CONFORMANCE WITH FDOT #17346, DRAWING #3 OF 8.
- 2. HANDICAP RAMPS SHALL COMPLY WITH FLORIDA DEPARTMENT OF TRANSPORTATION ROADWAY AND TRAFFIC DESIGN STANDARDS INDEX NO. 0304. AND CITY OF ORLANDO REQUIREMENTS WITH TRUNKATED DOME MATS.

GEOMETRY NOTES

POWER POLE

- 1. ALL SURVEY DATA USED AND CONDITIONS ASSUMED TO BE PRESENT IN PREPARATION OF THESE PLANS WAS PROVIDED BY GRUSENMEYER—SCOTT & ASSOC., INC.
- 2. THE CONTRACTOR SHALL VERIFY AND LOCATE ALL VERTICAL AND HORIZONTAL CONTROL POINTS PRIOR TO CONSTRUCTION. IF ANY DISCREPANCIES SHOULD BE FOUND, THE CONTRACTOR SHALL NOTIFY THE ENGINEER AND SURVEYOR OF THE CONDITION IN WRITING PRIOR TO COMMENCING HIS CONSTRUCTION ACTIVITIES.
- 3. ALL PAVEMENT OFFSETS, RADII AND DIMENSIONS SHOWN ARE TO PROPOSED EDGE OF PAVEMENT, UNLESS OTHERWISE NOTED.
- 4. THE CONTRACTOR SHALL STAKE ALL IMPROVEMENTS USING THE GEOMETRIC DATA PROVIDED. IT IS THE CONTRACTORS SOLE RESPONSIBILITY TO COMPLETELY STAKE AND CHECK ALL IMPROVEMENTS TO ENSURE ADEQUATE POSITIONING, BOTH HORIZONTAL AND VERTICAL, PRIOR TO THE INSTALLATION OF ANY IMPROVEMENTS.

<u>LEGEND</u>	EXIST.	<u>NEW</u>
ASPHALT PAVEMENT		
CONCRETE WALK		
CONCRETE CURB		

0




Seal: Majid Kalaghchi P.E. 41046


AGNOLIA DENTAL CENTER


90% REVIEW SET 03-12-14
PERMIT SET 3-24-14

Issue Date and Purpose
Project
Number: 1359

Drawn by:
D. FORSYTH
Checked:
M. KALAGHCHI
File No:

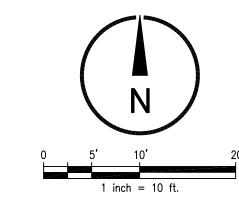

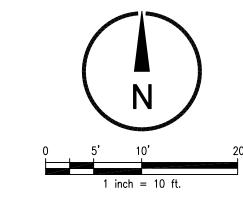

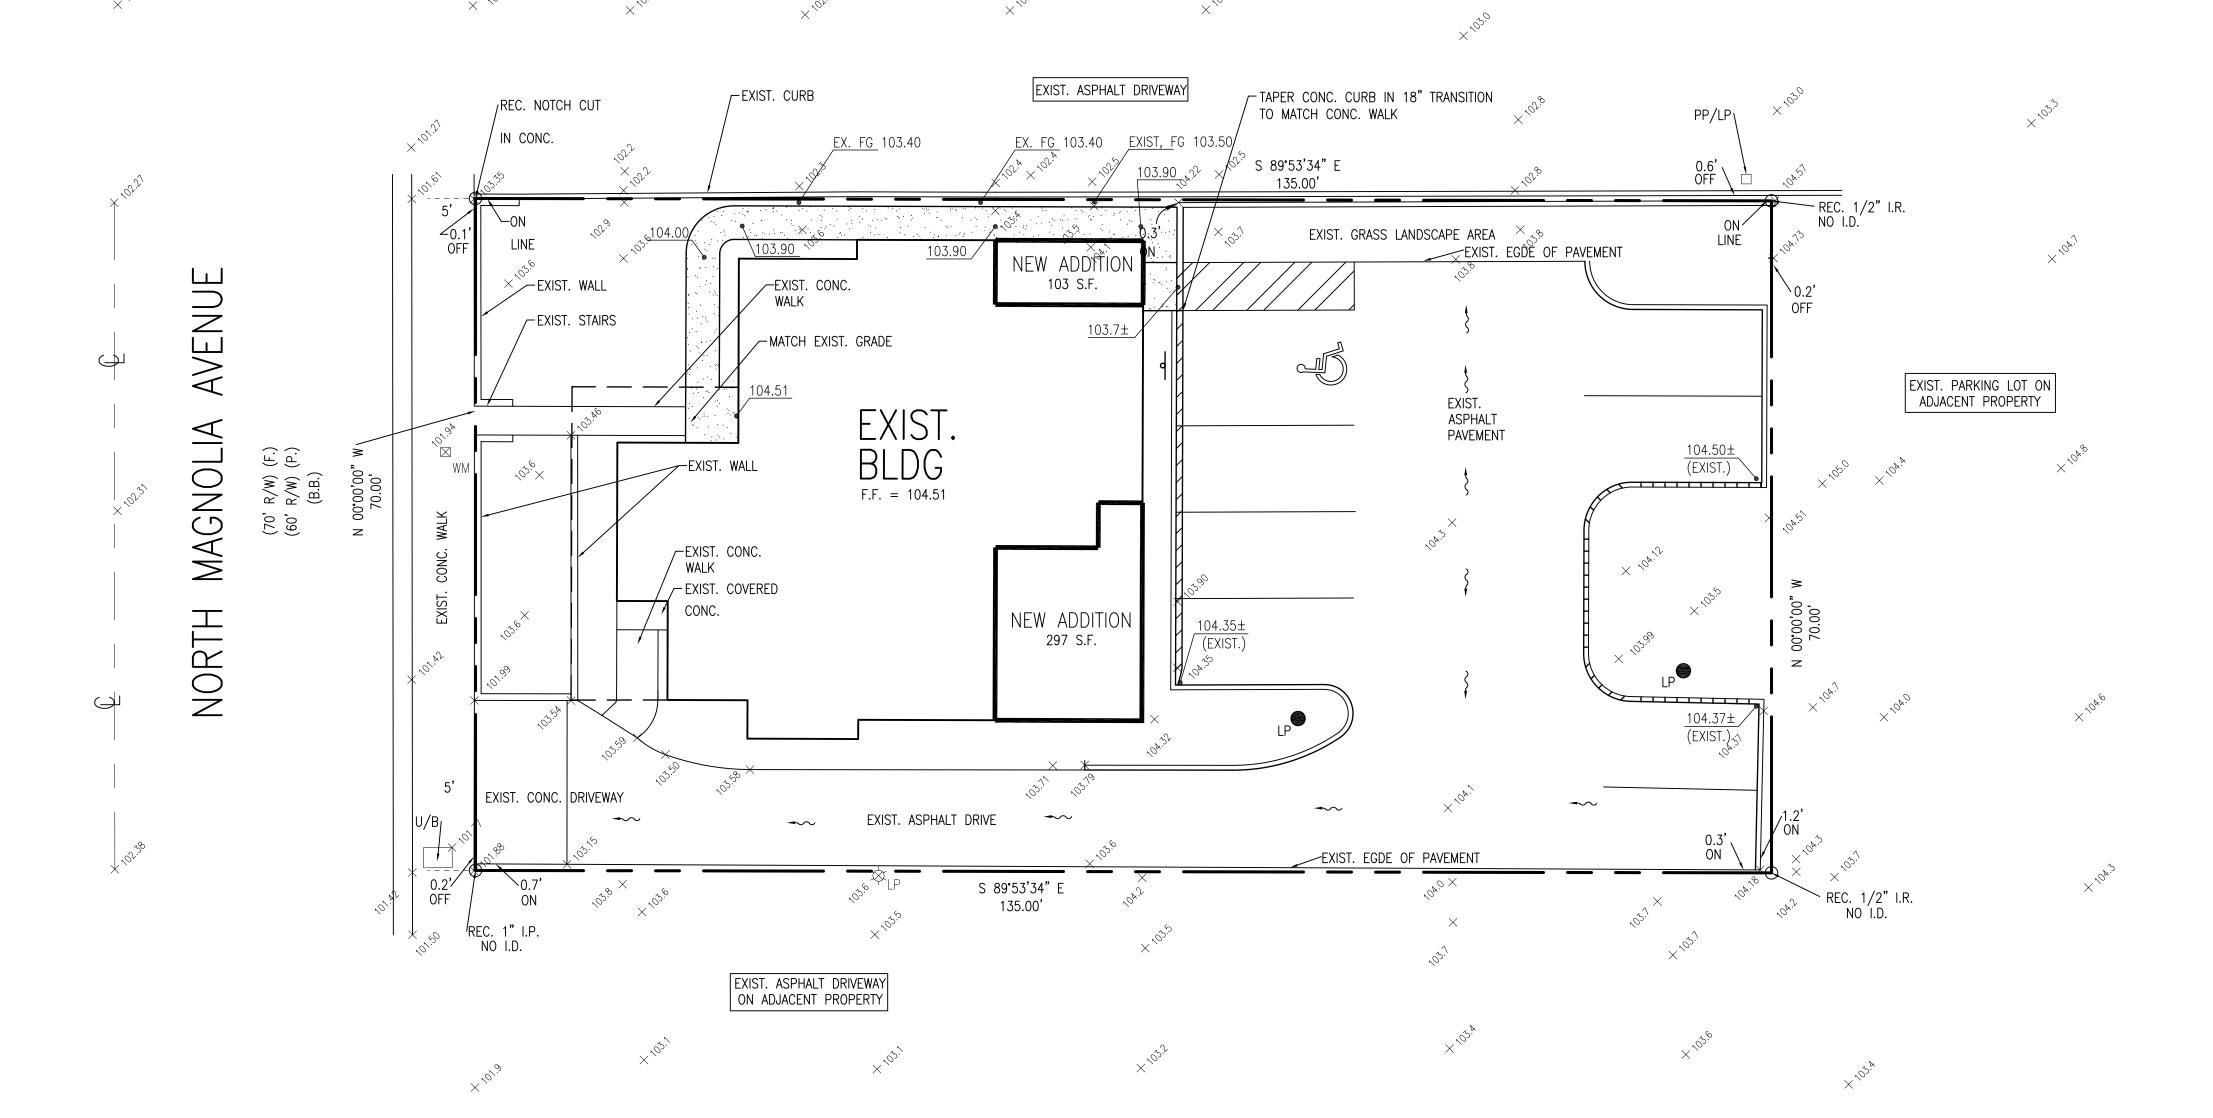

GRADING AND DRAINAGE PLAN SCALE: 1"=10'

GENERAL NOTES:

- 1. ALL DISTURBED AREAS SHALL BE SODDED.
- 2. SEE SHEET COO1 FOR EROSION & SEDEMENTATION CONTROL NOTES.
- 3. CONTRACTOR SHALL ENSURE POSITIVE DRAINAGE BY MATCHING DRAINAGE PATTERN TO EXISTING CONDITION AS MUSH AS POSSIBLE.
- 4. NET INCREASE IN IMPERVIOUS AREA IS 127 S.F.

<u>LEGEND</u>		
	EXIST.	<u>NEW</u>
FINISH GRADE	9879	97.70
FLOW PATTERN		~~
CONTOUR	100	100
STORM DRAIN INLET		
MITERED END SECTION		
STORM DRAIN INLET		\triangle
STORM DRAIN LINE	SD	—— SD ——
DRAINAGE BOUNDRY		

GRADING

90% REVIEW SET 03-12-14


PERMIT SET 3-24-14


Issue Date and Purpose


C201


Project Number:


Drawn by:
D. FORSYTH
Checked:
M. KALAGHCHI
File No:
0557/0557

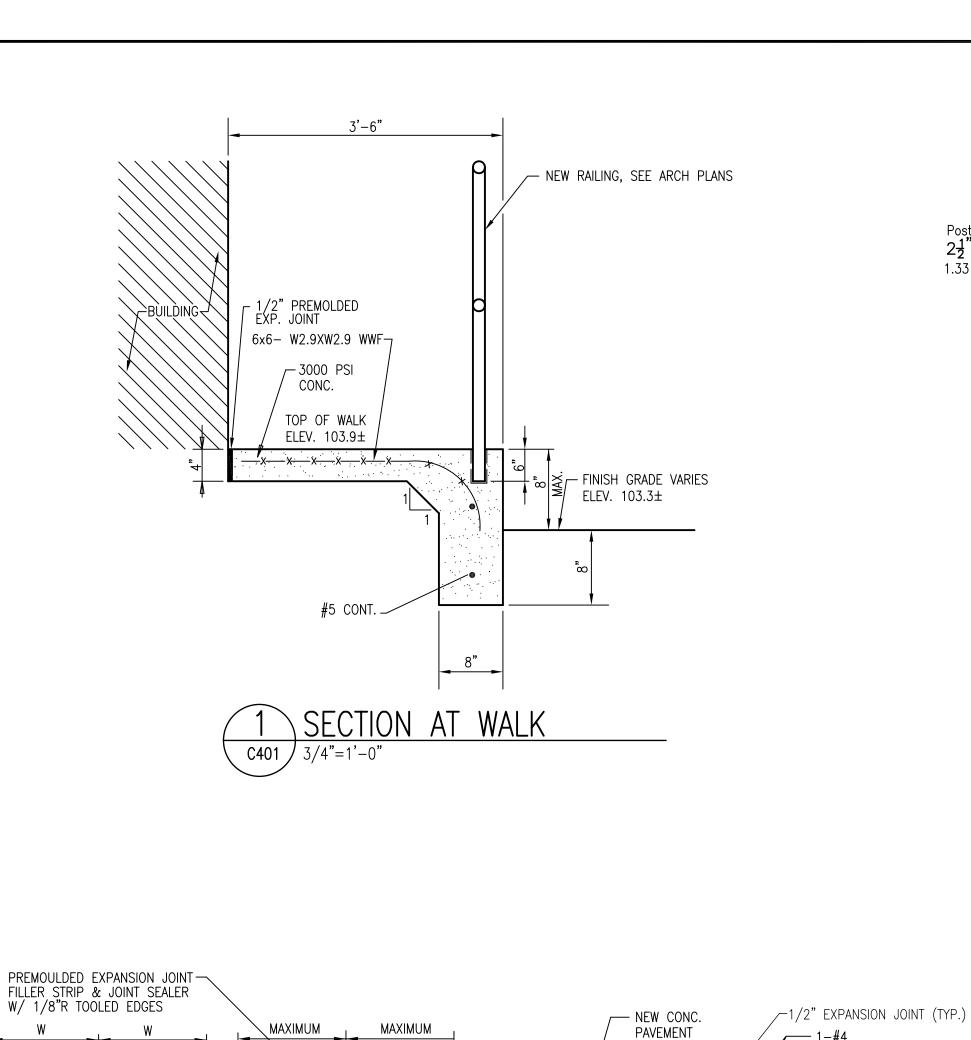

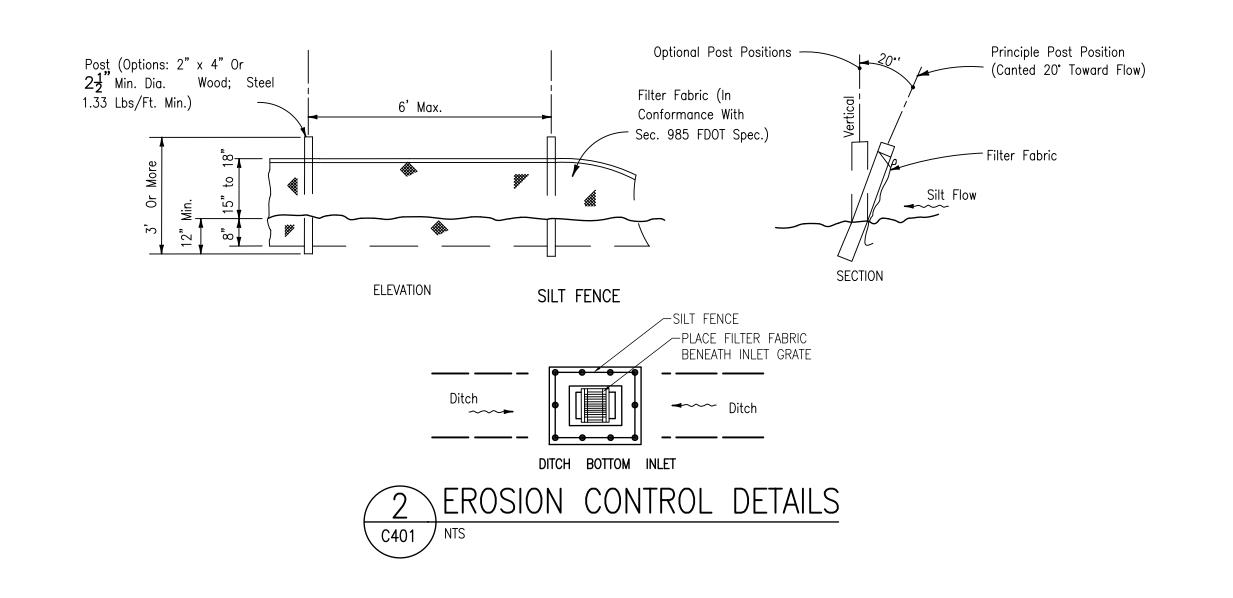

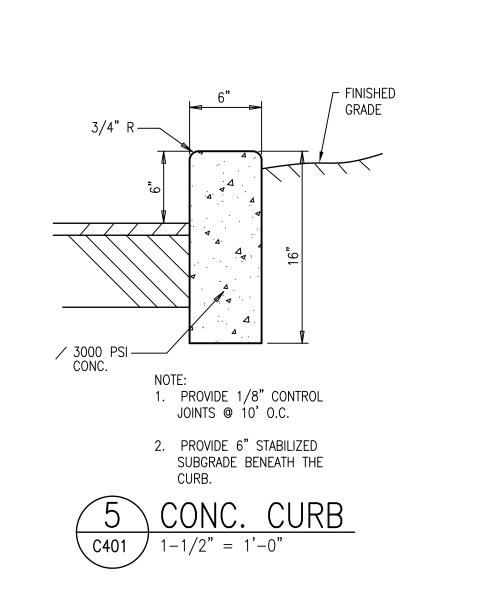

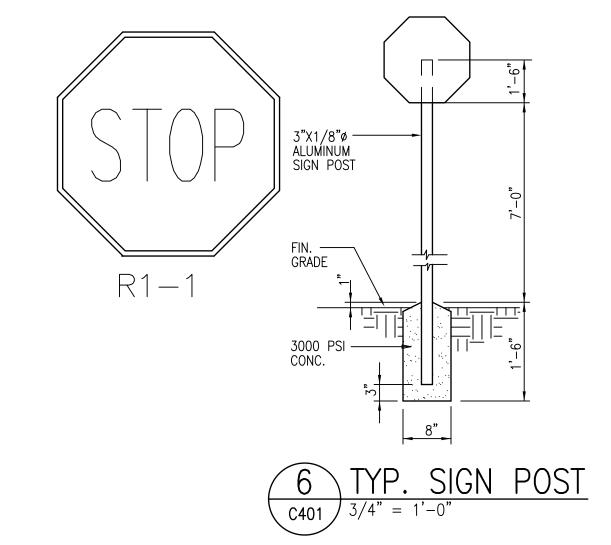

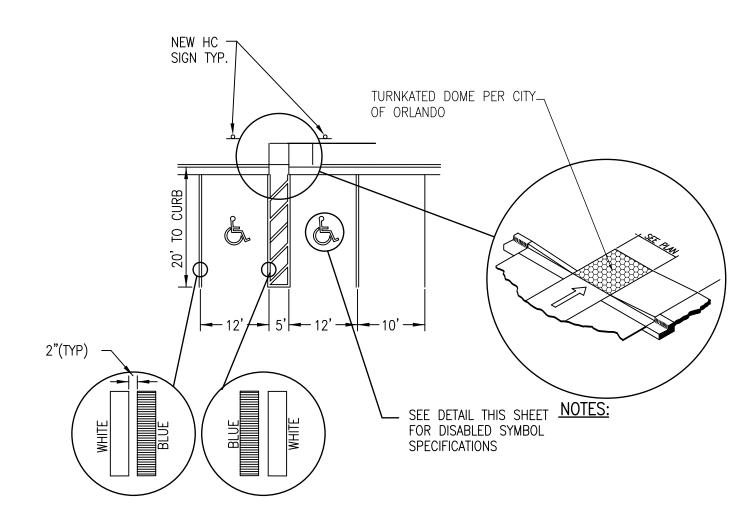

- 1. EACH SUCH PARKING SPACE SHALL BE CONSPICUOUSLY OUTLINED IN BLUE PAINT, AND SHALL BE POSTED AND MAINTAINED WITH A PERMANENT, ABOVE GRADE SIGN BEARING THE INTERNATIONAL SYMBOL OF ACCESSIBILITY, OR THE CAPTION "PARKING BY DISABLED PERMIT ONLY." OR BEARING BOTH SUCH SYMBOL AND CAPTION. SUCH SIGNS SHALL NOT BE OBSCURED BY A VEHICLE PARKED IN THE SPACE. ALL HANDICAPPED PARKING SPACES MUST BE SIGNED AND MARKED IN ACCORDANCE WITH THE STANDARDS ADOPTED BY THE DEPARTMENT OF TRANSPORTATION.
- 2. FL DOT RECOMMENDS MEASURING PARKING SPACE WIDTH FROM CENTER TO CENTER BETWEEN BLUE AND WHITE STRIPES.

HANDICAP STRIPING DETAIL NOT TO SCALE C401

4 CONC. SIDEWALK DETAIL C401 NOT TO SCALE

EXPANSION JOINT - E.J.

1" DEEP 1/8"R TOOLED JOINT

3000 PSI AIR→

ENTRAINED CONC.

<u>CONTRACTION JOINT - C.J.</u>


NOTES: 1. A THICKENED EDGE SHALL BE PROVIDED BETWEEN SIDEWALK AND DRIVEWAYS OR PARKING LOT.


PROVIDE POSITIVE DRAINAGE.


2. SLOPE CONC. SIDEWALKS AWAY FROM BUILDINGS TO


3. THE CROSS SLOPE OF THE SIDEWALK SHALL NOT EXCEED 2%.


─ 6" COMPACTED SUBGRADE —

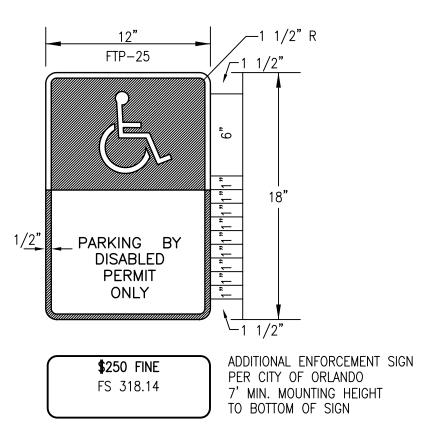

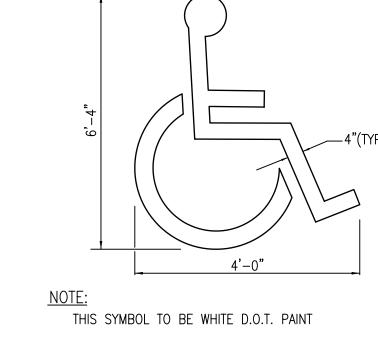

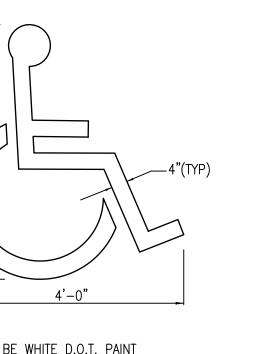

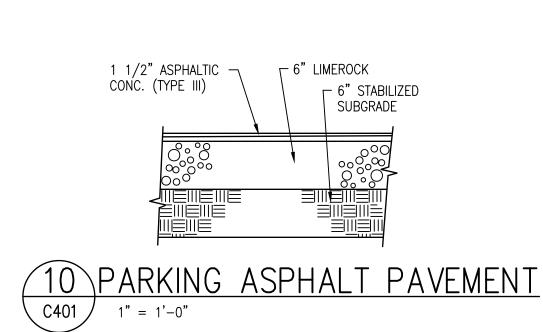

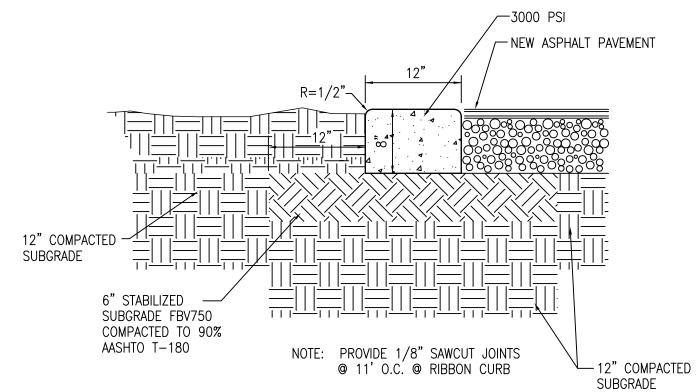

9 HANDICAP PARKING SYMBOL DETAIL HANDICAP SIGN DETAIL C401 NOT TO SCALE C401 NOT TO SCALE

CONC. WALK - THCKND EDGE

4. PROVIDE CONTROL JOINTS @ INTERVALS EQUAL TO

5. PROVIDE PREMOLDED EXPANSION JOINT WHERE CONC.

WALK ABUTS BLDG., POLES, AND OTHER CONC. WALKS.

SIDEWALK WIDTH (W).

RIBBON CURB DETAIL 1"=1'-0" C401 /

Seal: Majid Kalaghchi P.E. 41046


CENTE **DENTAL**

SHEET

DETAIL 90% REVIEW SET 03-12-14 PERMIT SET 3-24-14

Issue Date and Purpose Project 1352 Number:

Drawn by:
D. FORSYTH
Checked:
M. KALAGHCHI
File No: C401

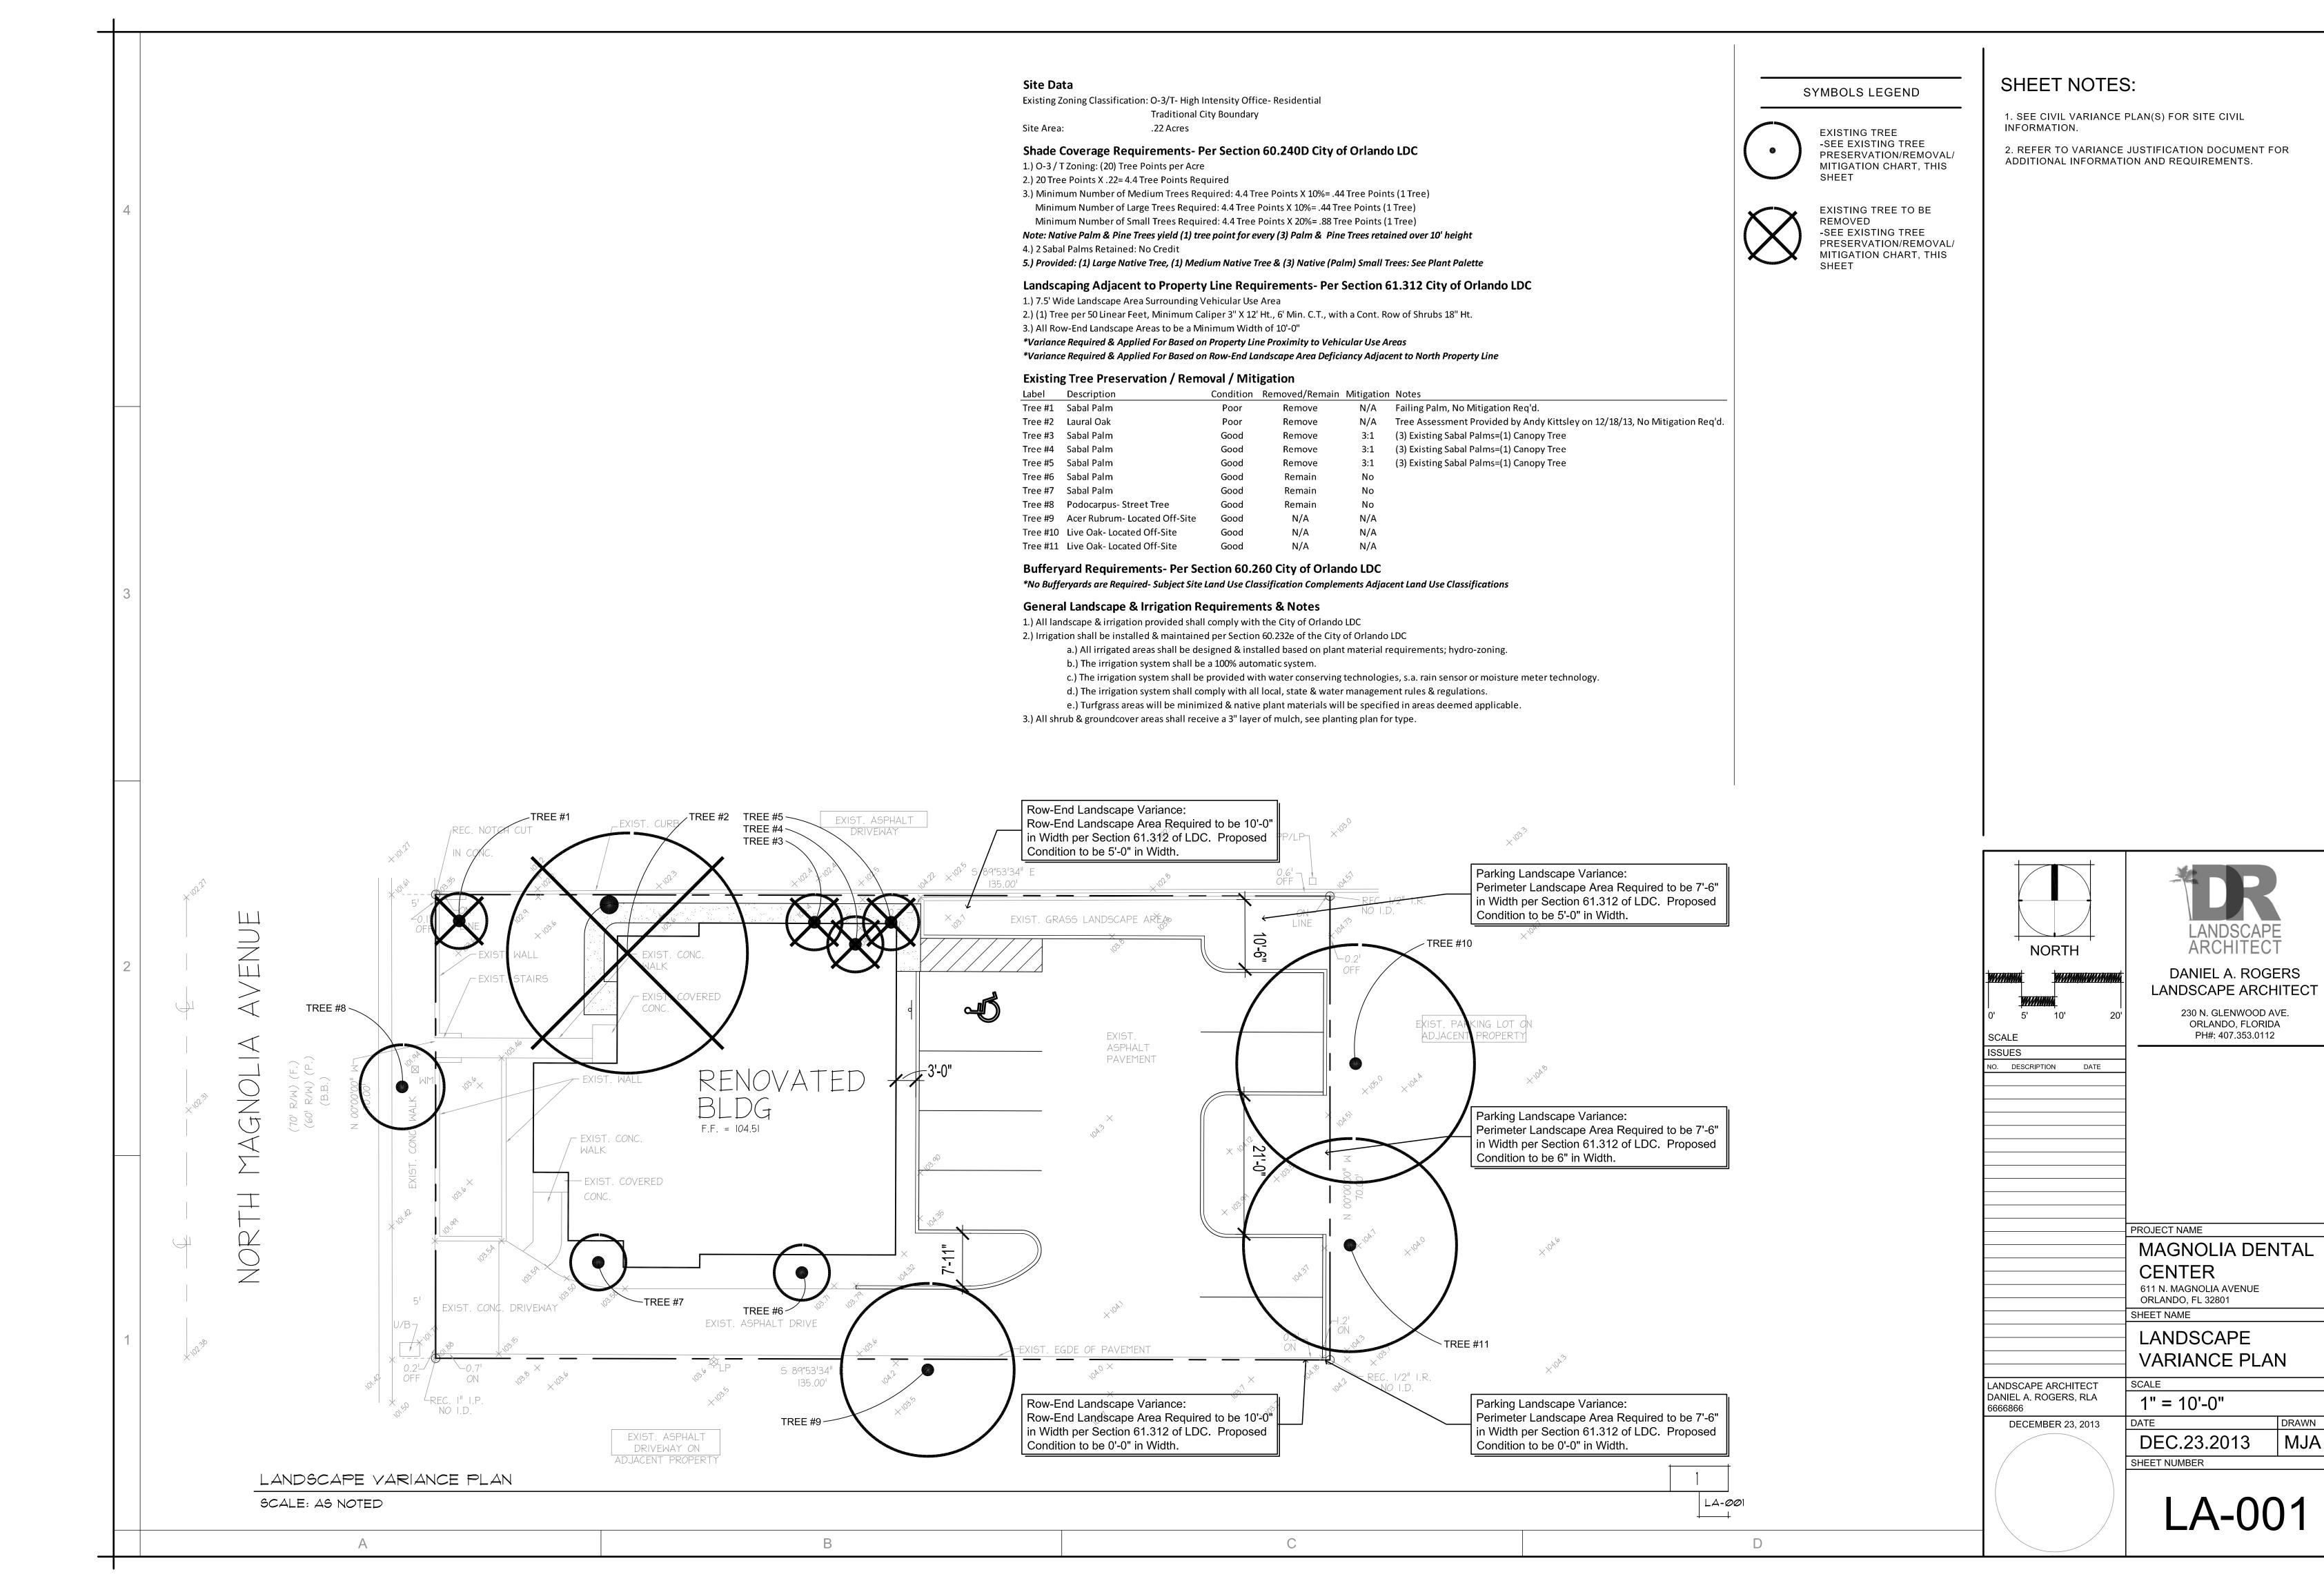

Site Data

Existing Zoning Classification: O-3/T- High Intensity Office- Residential

Traditional City Boundary

Site Area:

Shade Coverage Requirements- Per Section 60.240D City of Orlando LDC

1.) O-3 / T Zoning: (20) Tree Points per Acre

2.) 20 Tree Points X .22= 4.4 Tree Points Required

3.) Minimum Number of Medium Trees Required: 4.4 Tree Points X 10%= .44 Tree Points (1 Tree)

Minimum Number of Large Trees Required: 4.4 Tree Points X 10%= .44 Tree Points (1 Tree) Minimum Number of Small Trees Required: 4.4 Tree Points X 20%= .88 Tree Points (1 Tree)

Note: Native Palm & Pine Trees yield (1) tree point for every (3) Palm & Pine Trees retained over 10' height

4.) 2 Sabal Palms Retained: No Credit

5.) Provided: (1) Large Native Tree, (1) Medium Native Tree & (3) Native (Palm) Small Trees: See Plant Palette

Landscaping Adjacent to Property Line Requirements- Per Section 61.312 City of Orlando LDC

1.) 7.5' Wide Landscape Area Surrounding Vehicular Use Area

2.) (1) Tree per 50 Linear Feet, Minimum Caliper 3" X 12' Ht., 6' Min. C.T., with a Cont. Row of Shrubs 18" Ht.

3.) All Row-End Landscape Areas to be a Minimum Width of 10'-0"

*Variance Required & Applied For Based on Property Line Proximity to Vehicular Use Areas *Variance Required & Applied For Based on Row-End Landscape Area Deficiancy Adjacent to North Property Line

Existing Tree Preservation / Removal / Mitigation

Label	Description	Condition	Removed/Remain	Mitigation	Notes
Tree #1	Sabal Palm	Poor	Remove	N/A	Failing Palm, No Mitigation Req'd.
Tree #2	Laural Oak	Poor	Remove	N/A	Tree Assessment Provided by Andy Kittsley on 12/18/13, No Mitigation Req'd
Tree #3	Sabal Palm	Good	Remove	3:1	(3) Existing Sabal Palms=(1) Canopy Tree
Tree #4	Sabal Palm	Good	Remove	3:1	(3) Existing Sabal Palms=(1) Canopy Tree
Tree #5	Sabal Palm	Good	Remove	3:1	(3) Existing Sabal Palms=(1) Canopy Tree
Tree #6	Sabal Palm	Good	Remain	No	ALTERNATION AND ADDRESS OF THE PROPERTY OF THE
Tree #7	Sabal Palm	Good	Remain	No	
Tree #8	Podocarpus- Street Tree	Good	Remain	No	
Tree #9	Acer Rubrum- Located Off-Site	Good	N/A	N/A	
Tree #10	Live Oak- Located Off-Site	Good	N/A	N/A	
Tree #11	Live Oak- Located Off-Site	Good	N/A	N/A	

Bufferyard Requirements- Per Section 60.260 City of Orlando LDC

*No Bufferyards are Required- Subject Site Land Use Classification Complements Adjacent Land Use Classifications

General Landscape & Irrigation Requirements & Notes

1.) All landscape & irrigation provided shall comply with the City of Orlando LDC

2.) Irrigation shall be installed & maintained per Section 60.232e of the City of Orlando LDC

- a.) All irrigated areas shall be designed & installed based on plant material requirements; hydro-zoning.
- b.) The irrigation system shall be a 100% automatic system.
- c.) The irrigation system shall be provided with water conserving technologies, s.a. rain sensor or moisture meter technology.
- d.) The irrigation system shall comply with all local, state & water management rules & regulations.
- e.) Turfgrass areas will be minimized & native plant materials will be specified in areas deemed applicable.
- 3.) All shrub & groundcover areas shall receive a 3" layer of mulch, see planting plan for type.

SYMBOLS LEGEND



EXISTING TREE -SEE EXISTING TREE PRESERVATION/REMOVAL/ MITIGATION CHART, THIS




LA-100

EXISTING TREE TO BE REMOVED -SEE EXISTING TREE PRESERVATION/REMOVAL/ MITIGATION CHART, THIS

SHEET NOTES:

1. SEE CIVIL PLAN(S) FOR SITE CIVIL INFORMATION.

2. REFER TO VARIANCE JUSTIFICATION DOCUMENT FOR ADDITIONAL INFORMATION AND REQUIREMENTS.

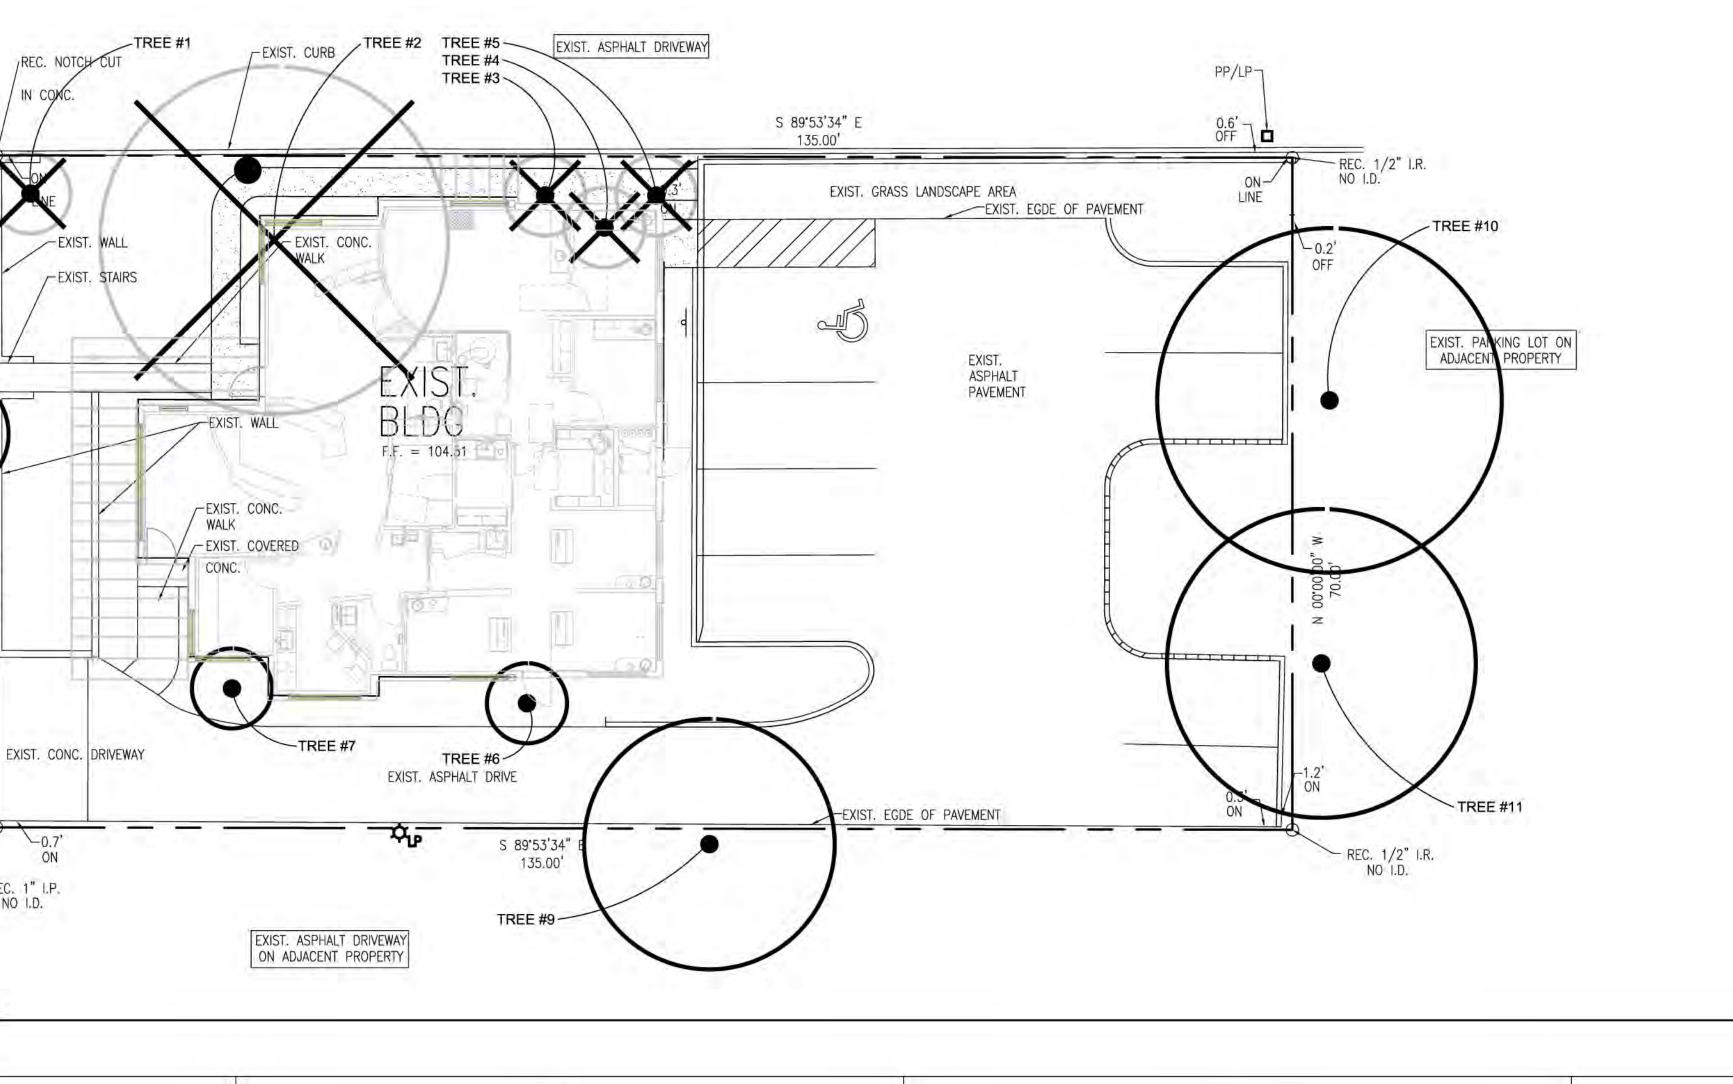

AVENUE

MAGNOLIA


NORTH

TREE #8

0.2'_/ OFF

EXISTING TREE PLAN

SCALE: AS NOTED

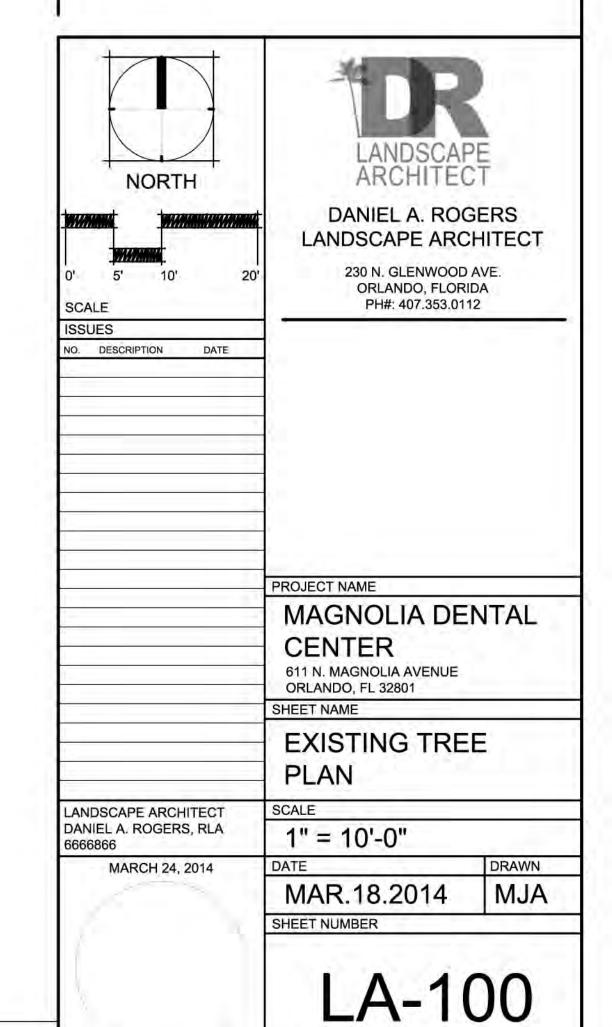

PLANT PALETTE BOTANICAL NAME COMMON NAME SPECIFICATIONS FG, multi-trunk, 12'-14' Ht. min., Specimen Betula nigra River Birch Tree 1 Gal. plug @ 18" O.C. JCO Juniperus conferta Shore Juniper Liriope muscari 'Green Giant' 1 Gal., full in pot @ 18" O.C. LMG Green Giant Liriope OJA 29 Ophiopogon japonicum Dwarf Mondo Grass 1 Gal., 15" O.C. POD 20 Podocarpus macrophyllus Common Podocarpus 7 Gal., 42" Ht x 30" Sprd., 36" O.C. PSE Pennisetum setaceum Fountain Grass 3 Gal., 30" Ht. x 24" Sprd., 24" O.C. SAP Sabal palmetto Cabbage Palm See plan for C.T. heights SRE Strelitzia reginae Orange Bird of Paradise 7 Gal., 36" Ht. x 36" Sprd. STR Sansevieria trifasciata Snake Plant 1 Gal,. 18" Ht. min. Confederate Jasmine Vine 1 Gal., full in pot, trained to architectural trellis TAC Trachelospermum jasminoides TRA Trachelospermum asiaticum 1 Gal., 18" O.C. Asiatic Jasmine ZFL 37 Zamia floridana 3 Gal., 18" Ht. x 18" Sprd, 24" O.C. Coontie ZFR 1 Zamia furfuracea Cardboard Palm 7 Gal., 36" x 36" Full

SYMBOLS LEGEND

——PLANT QUANTITY


2/QVI PLANT SYMBOL


SHEET NOTES:


1. ALL PLANT MATERIAL SHALL MEET OR EXCEED THE STANDARDS OF FLORIDA NO 1 AS GIVEN IN "GRADES AND STANDARDS FOR NURSERY PLANTS 1998," STATE OF FLORIDA, DEPARTMENT OF AGRICULTURE, TALLAHASSEE, AND ANY AMENDMENTS THERETO.

2. THE LANDSCAPE ARCHITECT MAY REJECT ANY PLANT MATERIAL BROUGHT TO THE SITE WHICH HE DEEMS TO BE OF INFERIOR QUALITY OR APPEARANCE.

- 3. ALL PLANT BEDS SHALL BE TOP DRESSED WITH A MINIMUM OF 3" DEPTH PINE BARK MULCH MINI-NUGGETS. MAINTAIN A 4" CLEAR SPACE BETWEEN MULCH AND THE PLANT STEM.
- 4. ALL TREES SHALL HAVE ALL SYNTHETIC BURLAP REMOVED FROM THE ENTIRE ROOT BALL. JUTE BURLAP SHALL BE REMOVED FROM THE TOP ONE-THIRD OF THE ROOT BALL. THE TOP THREE ROWS OF SQUARES ON ALL CAGES AROUND THE ROOT BALLS SHALL BE CLIPPED OFF AND REMOVED.
- 5. THE CONTRACTOR IS RESPONSIBLE FOR MAINTENANCE OF THE SITE INCLUDING ALL MOWING, EDGING, TRIMMING, PRUNING & SPRAYING OF PESTICIDES & FUNGICIDES UNTIL THE TIME OF FINAL ACCEPTANCE BY THE OWNER.
- 6. ANY DAMAGE TO EXISTING HARDSCAPE/LANDSCAPE OUTSIDE THE LIMITS OF WORK SHALL BE REPAIRED BY THE CONTRACTOR AT NO EXPENSE TO THE OWNER.
- T. ALL DEBRIS FROM DEMOLITION SHALL BE REMOVED FROM THE SITE AND DISPOSED OF IN AN ACCEPTABLE MANNER.
- 8. A CERTIFIED ARBORIST SHALL BE USED FOR ANY PRUNING ASSOCIATED WITH EXISTING LIVE OAK TREES.

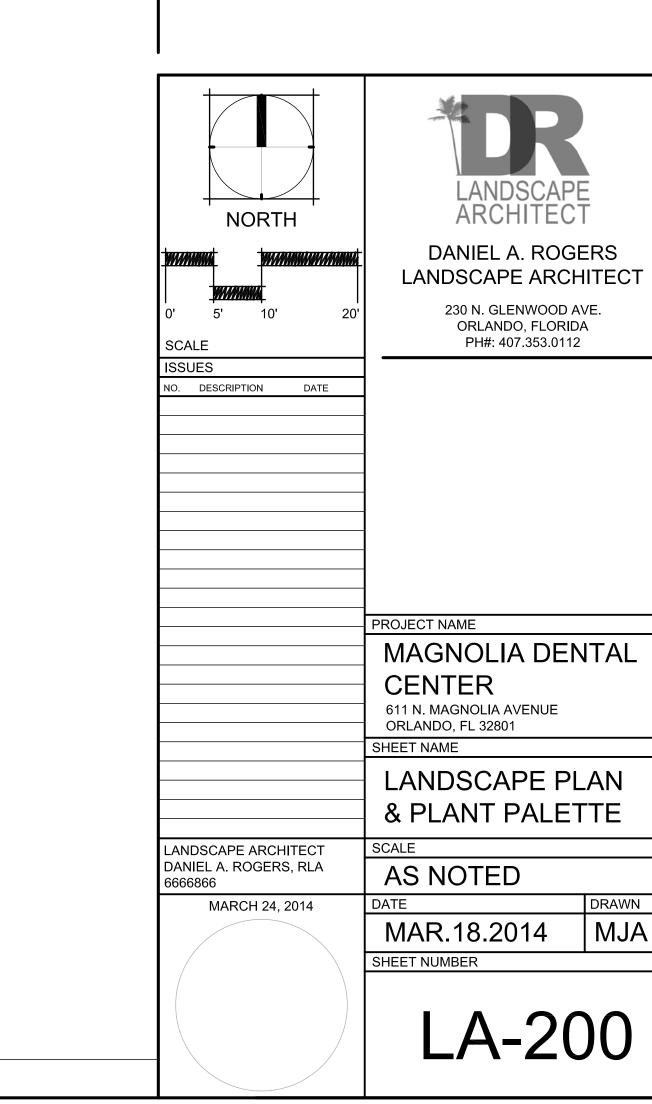

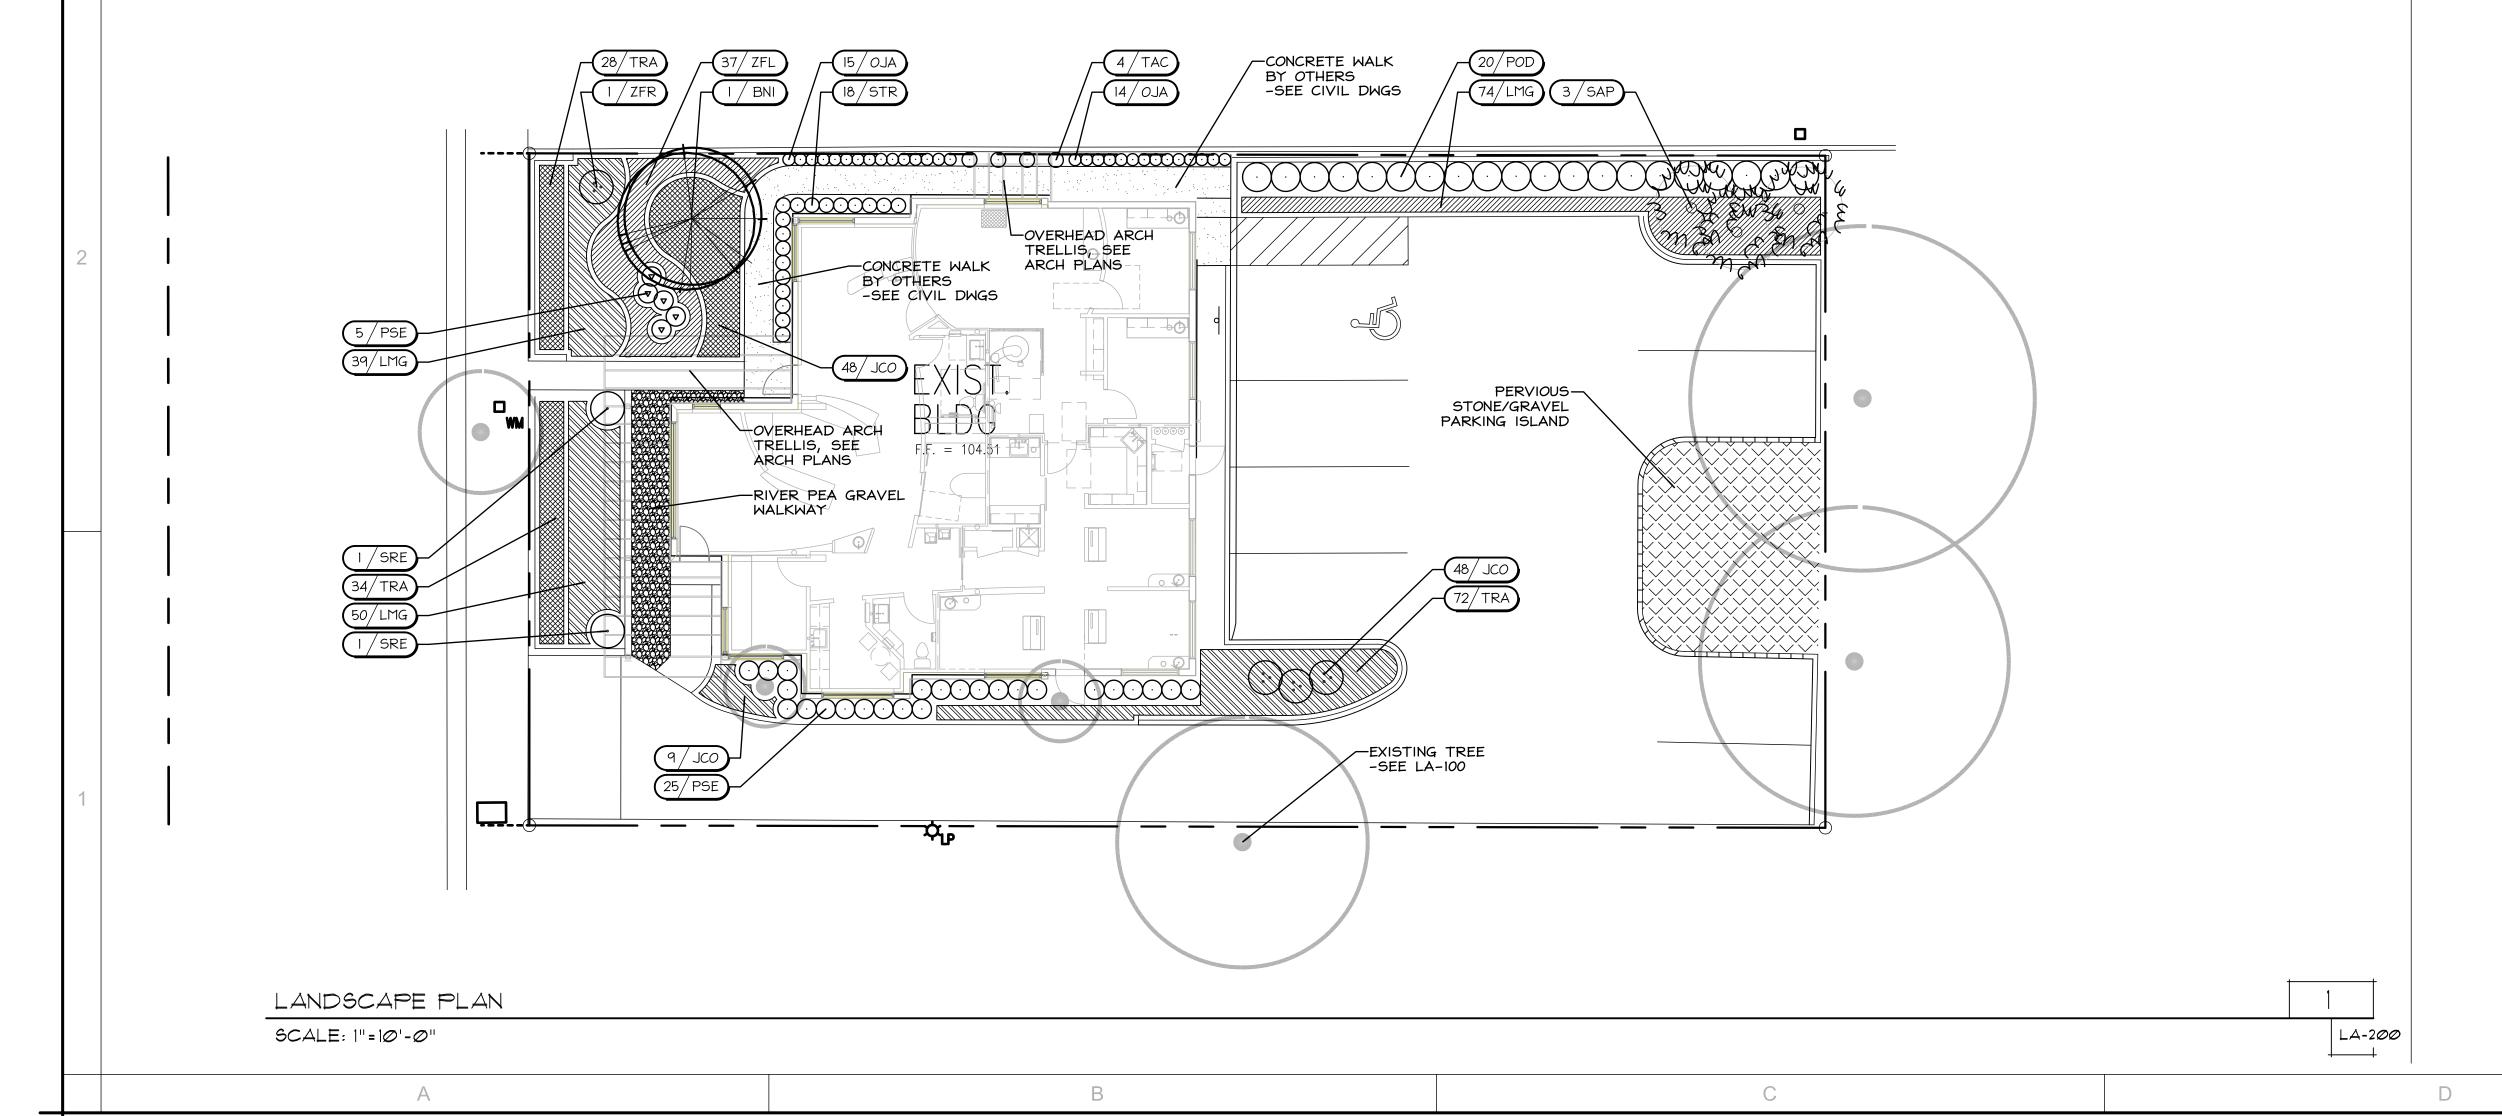

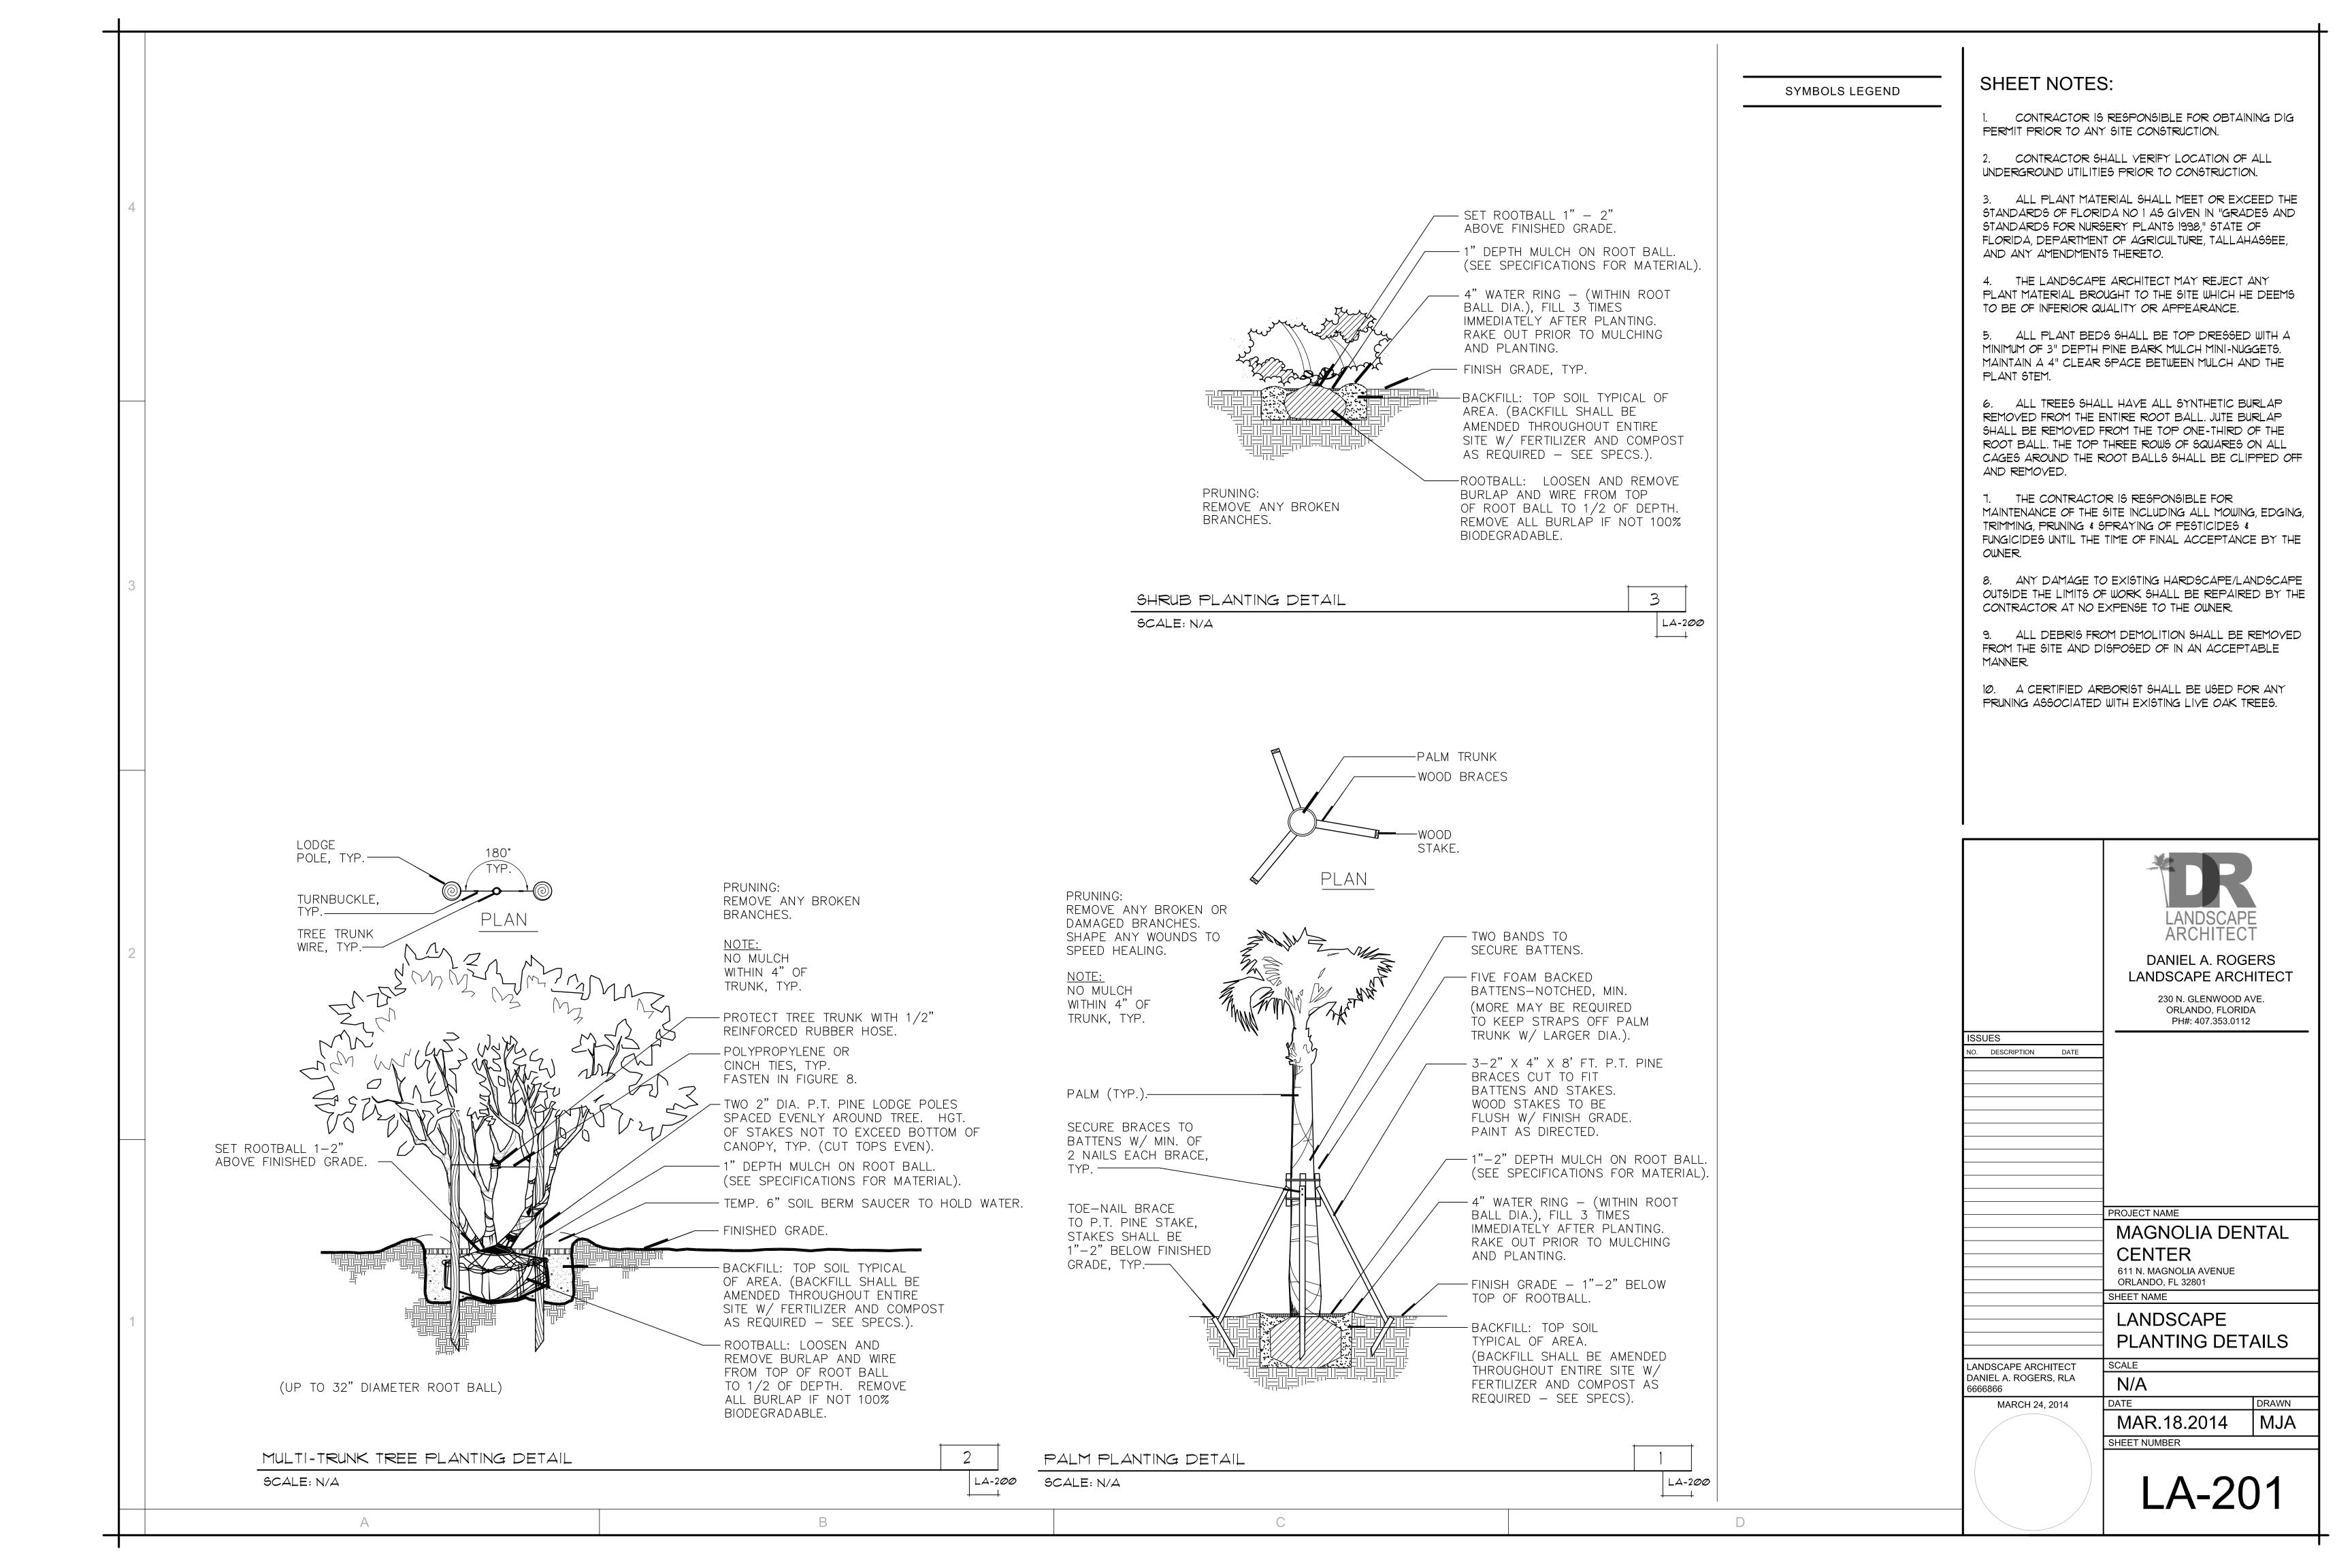



1422 delgany street, suite LL1 denver, colorado 80202 † 720.946.3228 f 720.946.3004 www.joearchitect.com



WJ WEEKS ARCHITECTURE LLC

1200 EAST HILLCREST STREET, SUITE 200 ORLANDO, FLORIDA 32803 407-234-3695

ARCHITECT OF RECORD

AA 26002407

PROJECT NAME MAGNOLIA DENTAL CENTER

AR 95341

611 NORTH MAGNOLIA ORLANDO, FLORIDA

PROJECT NUMBER

2013-0023

NAZAK HOLDINGS LLC

OWNER/DEVELOPER NAME


515 STATE ROAD 436 **SUITE 1010** CASSELBERRY, FLORIDA


No. Date ZONING VARIANCE 12-26-13 APPLICATION 3-24-14 DOCUMENTS

ELECTRICAL SITE PHOTOMETRIC PLAN


DRAWING NAME:

RBESCALE: AS INDICATED CONSULTING SERVICES, LLC DRAWING NUMBER:

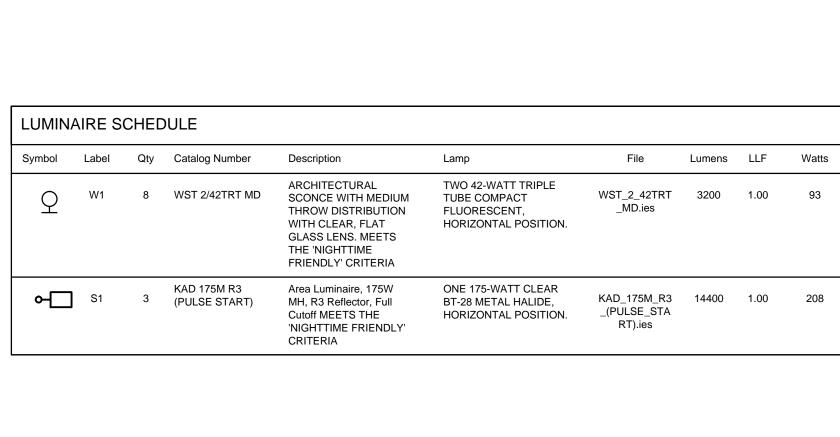

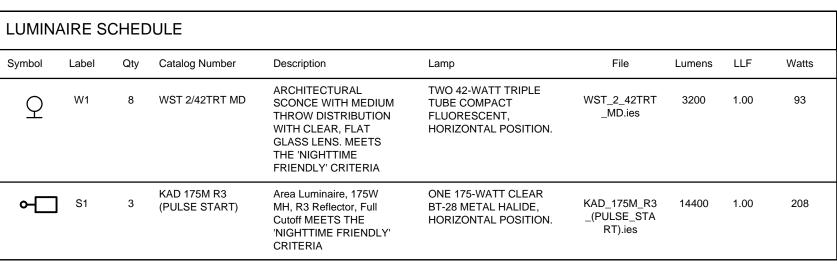

STATISTICS						
Description	Symbol	Avg	Max	Min	Max/Min	Avg/Min
Calc Zone #3	+	3.1 fc	21.5 fc	0.0 fc	N/A	N/A

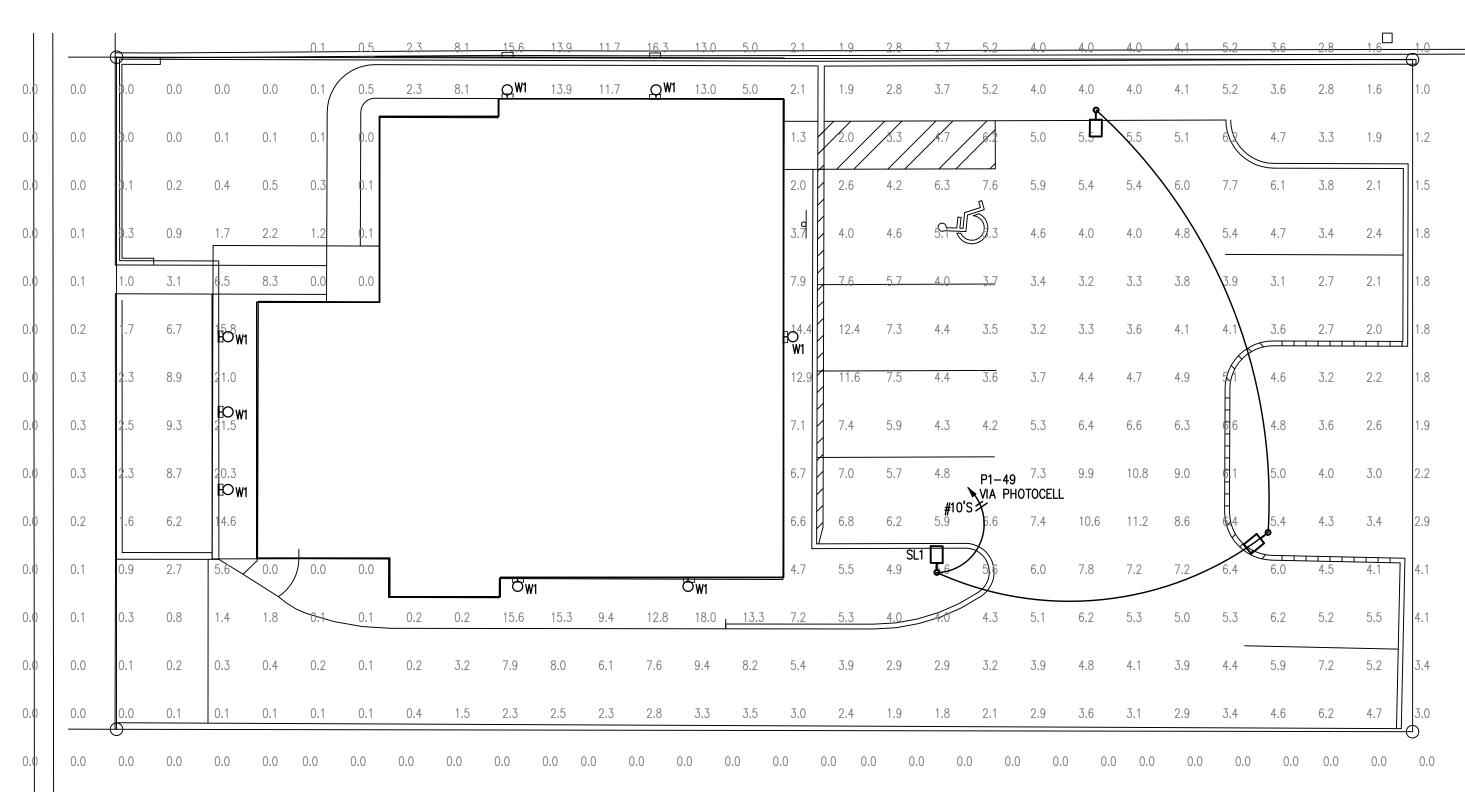

SCALE: 1" = 10'-0"



LITHONIA LIGHTING® Number

FEATURES & SPECIFICATIONS

INTENDED USE — Ideal for parking areas, street lighting, walkways and car lots. CONSTRUCTION — Rugged, die-cast, soft corner aluminum housing with 0.12" nominal wall thickness. Die-cast door frame has impact-resistant, tempered, glass lens that is fully gasketed with one-piece tubular silicone. Finish: Standard finish is dark bronze (DDB) polyester powder finish, with other architectural colors available.OPTICS — Anodized, aluminum reflectors: IES full cutoff distributions R2 (asymmetric), R3 (asymmetric), R4 (forward throw) and R5S (square) are interchangeable. High-performance anodized, segmented aluminum reflectors IES full cutoff distributions SR2 (asymmetric), SR3 (asymmetric) and SR4SC (forward throw, sharp cutoff). High-performance reflectors attach with tool-less fasteners and are rotatable and interchangeable. ELECTRICAL — Ballast: High pressure sodium: 70-150W is high reactance, high power factor. Constant wattage autotransformer for 200-400W. Metal halide: 70-150W is high reactance, high power factor and is standard with pulse-start ignitor technology. "SCWA" not required. Constant wattage autotransformer for 175-400W. Super CWA (pulse start ballast), 88% efficient and EISA legislation compliant, is required

is 100% factory-tested. Socket: Porcelain, horizontally oriented medium base socket for 70-150M. Mogul base socket for 175M and EPA: 1.2 ft.² above, and 70-400S, with copper alloy, nickel-plated screw shell and center contact. UL listed 1500W, 600V.

*Weight: 35.9 lbs (16.28 kg) LISTINGS – UL Listed (standard). CSA Certified (see Options). UL listed for 25°C ambient and wet locations.

Length: 17-1/2 (44.5) IP65 rated in accordance with standard IEC 529.

NGINFORMATION For shortest lead times, configure product using **bolded options**.

70S 70MHC^{1,2} R3 IES type III asymmetric⁷
100S 100MHC¹ asymmetric⁷
150S 150MHC R4 IES type IV

Standard reflectors R2 IES type II asymmetric⁷

forward throw⁷ R5S IES type V square

WARRANTY — 1-year limited warranty. Complete warranty terms located at www.acuitybrands.com/CustomerResources/Terms and conditions.aspx Note: Specifications subject to change without notice.

2505

100M¹ 320M⁴


150M 350M^{3,4}




SR2 IES type II

SR4SC IES type IV forward throw

asymmetric⁷

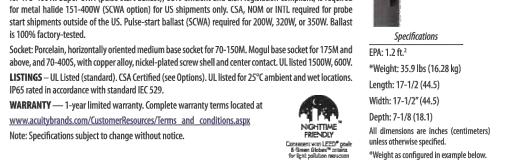

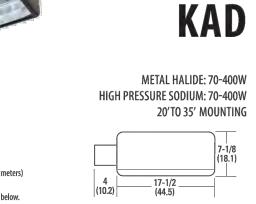

CONTOUR

Soft Square Lighting

KAD-M-S

Neight as configured in example below.				[110.2]	44.3)		1
			Exan	nple: KAD 400M F	R3 TB SCW	VA S	PD04 LP
Voltage	Ballast		Mounting ¹	2	Ţ		
120 208° 240° 277 347 480° TB ¹⁰ 23050HZ ¹¹	territories,		Ships in fix SPD RPD WBD WWD Ships sepan DAD12P DAD12WB WBA KMA KTMB	Square pole Round pole Wall bracket Wood or pole wall	ket ¹⁵	Arm 04 06 09 12	length 4" arm 6" arm 9" arm 12" arm

Options			Finish ²⁰		Lamp ²¹
Shipped installed in fixture SF Single fuse (120, 277, 347V) ¹⁶ DF Double fuse (208, 240, 480V) ¹⁶ PD Power tray ¹⁷ PER NEMA twist-lock receptacle only (no photocontrol) QRS Quartz restrike system ¹⁸ QRSTD QRS time delay ¹⁸ WTB Terminal wiring block ¹⁷	CSA CSA Certified INTL Available MH for probe start shipping outside the U.S. REGC1 California Title 20, effective 1/1/2010 Shipped separately ¹³ HS House side shield PE1 NEMA twist-lock PE (120, 208, 240V)	PE3 NEMA twist-lock PE (347V) PE4 NEMA twist-lock PE (480V) PE7 NEMA twist-lock PE (277V) SC Shorting cap for PER option VG Vandal guard ¹⁹ WG Wire guard ¹⁹	` '	DNAXD Natural aluminum DWHXD White DDBTXD Textured dark bronze DBLBXD Textured black DNATXD Textured natural aluminum DWHGXD Textured white	LPI La ind L/LP Le lar

	RS time del erminal wii	lay ¹⁸ ring block ¹⁷	208, 2	:40V)	(120,			DBLXD	Black				
		erate catalog	Three@120°			1 2 3 4 5	Not available with SCWA. Not available with 480V. These wattages do not cor California Title 20 regulatic Must be ordered with SCW These wattages require the option to be chosen for shi California for Title 20 comp REGC1 in not available in 3 Reduced jacket ED28 requi SR3 and SR4SC optics. House-side shield available.	ons. A. E REGC1 Ipments into Iliance. 250M IA7 or 480V. Ired for SR2,	11 Consult factory for 12 9" arm is required	or use in Canada. ballast (120, 208, da: 120, 277, 347V). available wattages. when two or more nted on a 90° drilling an accessory.	15 Available with: 16 Must specicy volume in SR4SC optics. 18 Max allowable 19 Prefix with KAL accessory. 20 See www.lithou additional color 21 Must be specifi with MHC. 22 Must use RPD0	oltage. N/A with T with SR2, SR3 and wattage lamp ind o when ordered as nia.com/archcolor options. ed. L/LP not avail	B. I cluded s an s for
OUTDOOR												KA	D-M-


_	Catalog Number Notes		Туре
FEATURES & SPECIFICATIONS	Notes		Туре
INTENDED USE — Square tapered direct-bury (embed for up to 40-foot mounting heights. CONSTRUCTION — Shaft: Concrete mix has a minimum strength of 6500 PSI and conforms with ASTM-C150. reinforcement is uncoated 7 wire stress relieved stra Steel spiral reinforcement conforms to ASTM-A82 and (11-gauge) diameter. Poles have a continuous taper of 0 A 3" x 5" handhole is located 24" above ground line and a conduit entrance is located 18" below ground line. Inse and conduit entrance are non-corrosive and weath frames and covers conform to ASTM-B240. Fasteners are high-strength galvanized or stainless stafinish — Poles have a smooth natural form finish, soft Stained color finishes available. GROUNDING — An 18" long, #4 stranded copper pigtail forced strand, is provided at pole top and at cable ent	times will vary depending on option Mounting¹ Tenonmounting T20 - 4STM-Days (a) Tenonmounting T20 - 2-3/8" O.D. (2" NPS)	ns selected. Consult with you	Direct Buri STC ETAPERED CONCRET Ur sales representativ le: STC 30 8-86X DM7 Finish Standard colors ⁵ (blank) Natural finish

NO	TES:
1	Concrete pole is not hollow. Fixtures should mount via tenon slipfitter. DM19 and DM28 drilling requires thru-bolt mounting.
2	The drilling template to be used for a particular luminaire depends on the luminaire that is used. Refer to the Technical Data Section of the Outdoor Binder for Drilling Templates.
3	Specify location and orientation when ordering option.
	For 1st "x": Specify the height in feet above base of pole.
	Example: 5ft = 5 and 20ft = 20
	For 2nd "x": Specify orientation from handhole (A,B,C,D)
	Refer to the Handhole Orientation diagram on this page.
4	Horizontal arm is 18" standard.
5	Poles are stained, not painted.
6	Finish must be specified. Additional colors available; see www.lithonia.com/

• Lithonia Lighting is not responsible for the foundation design. archcolors or Architectural Colors brochure (Form No. 794.3).

Do not erect poles without having fixtures installed.

Sheet #: Pole-STC PL-500

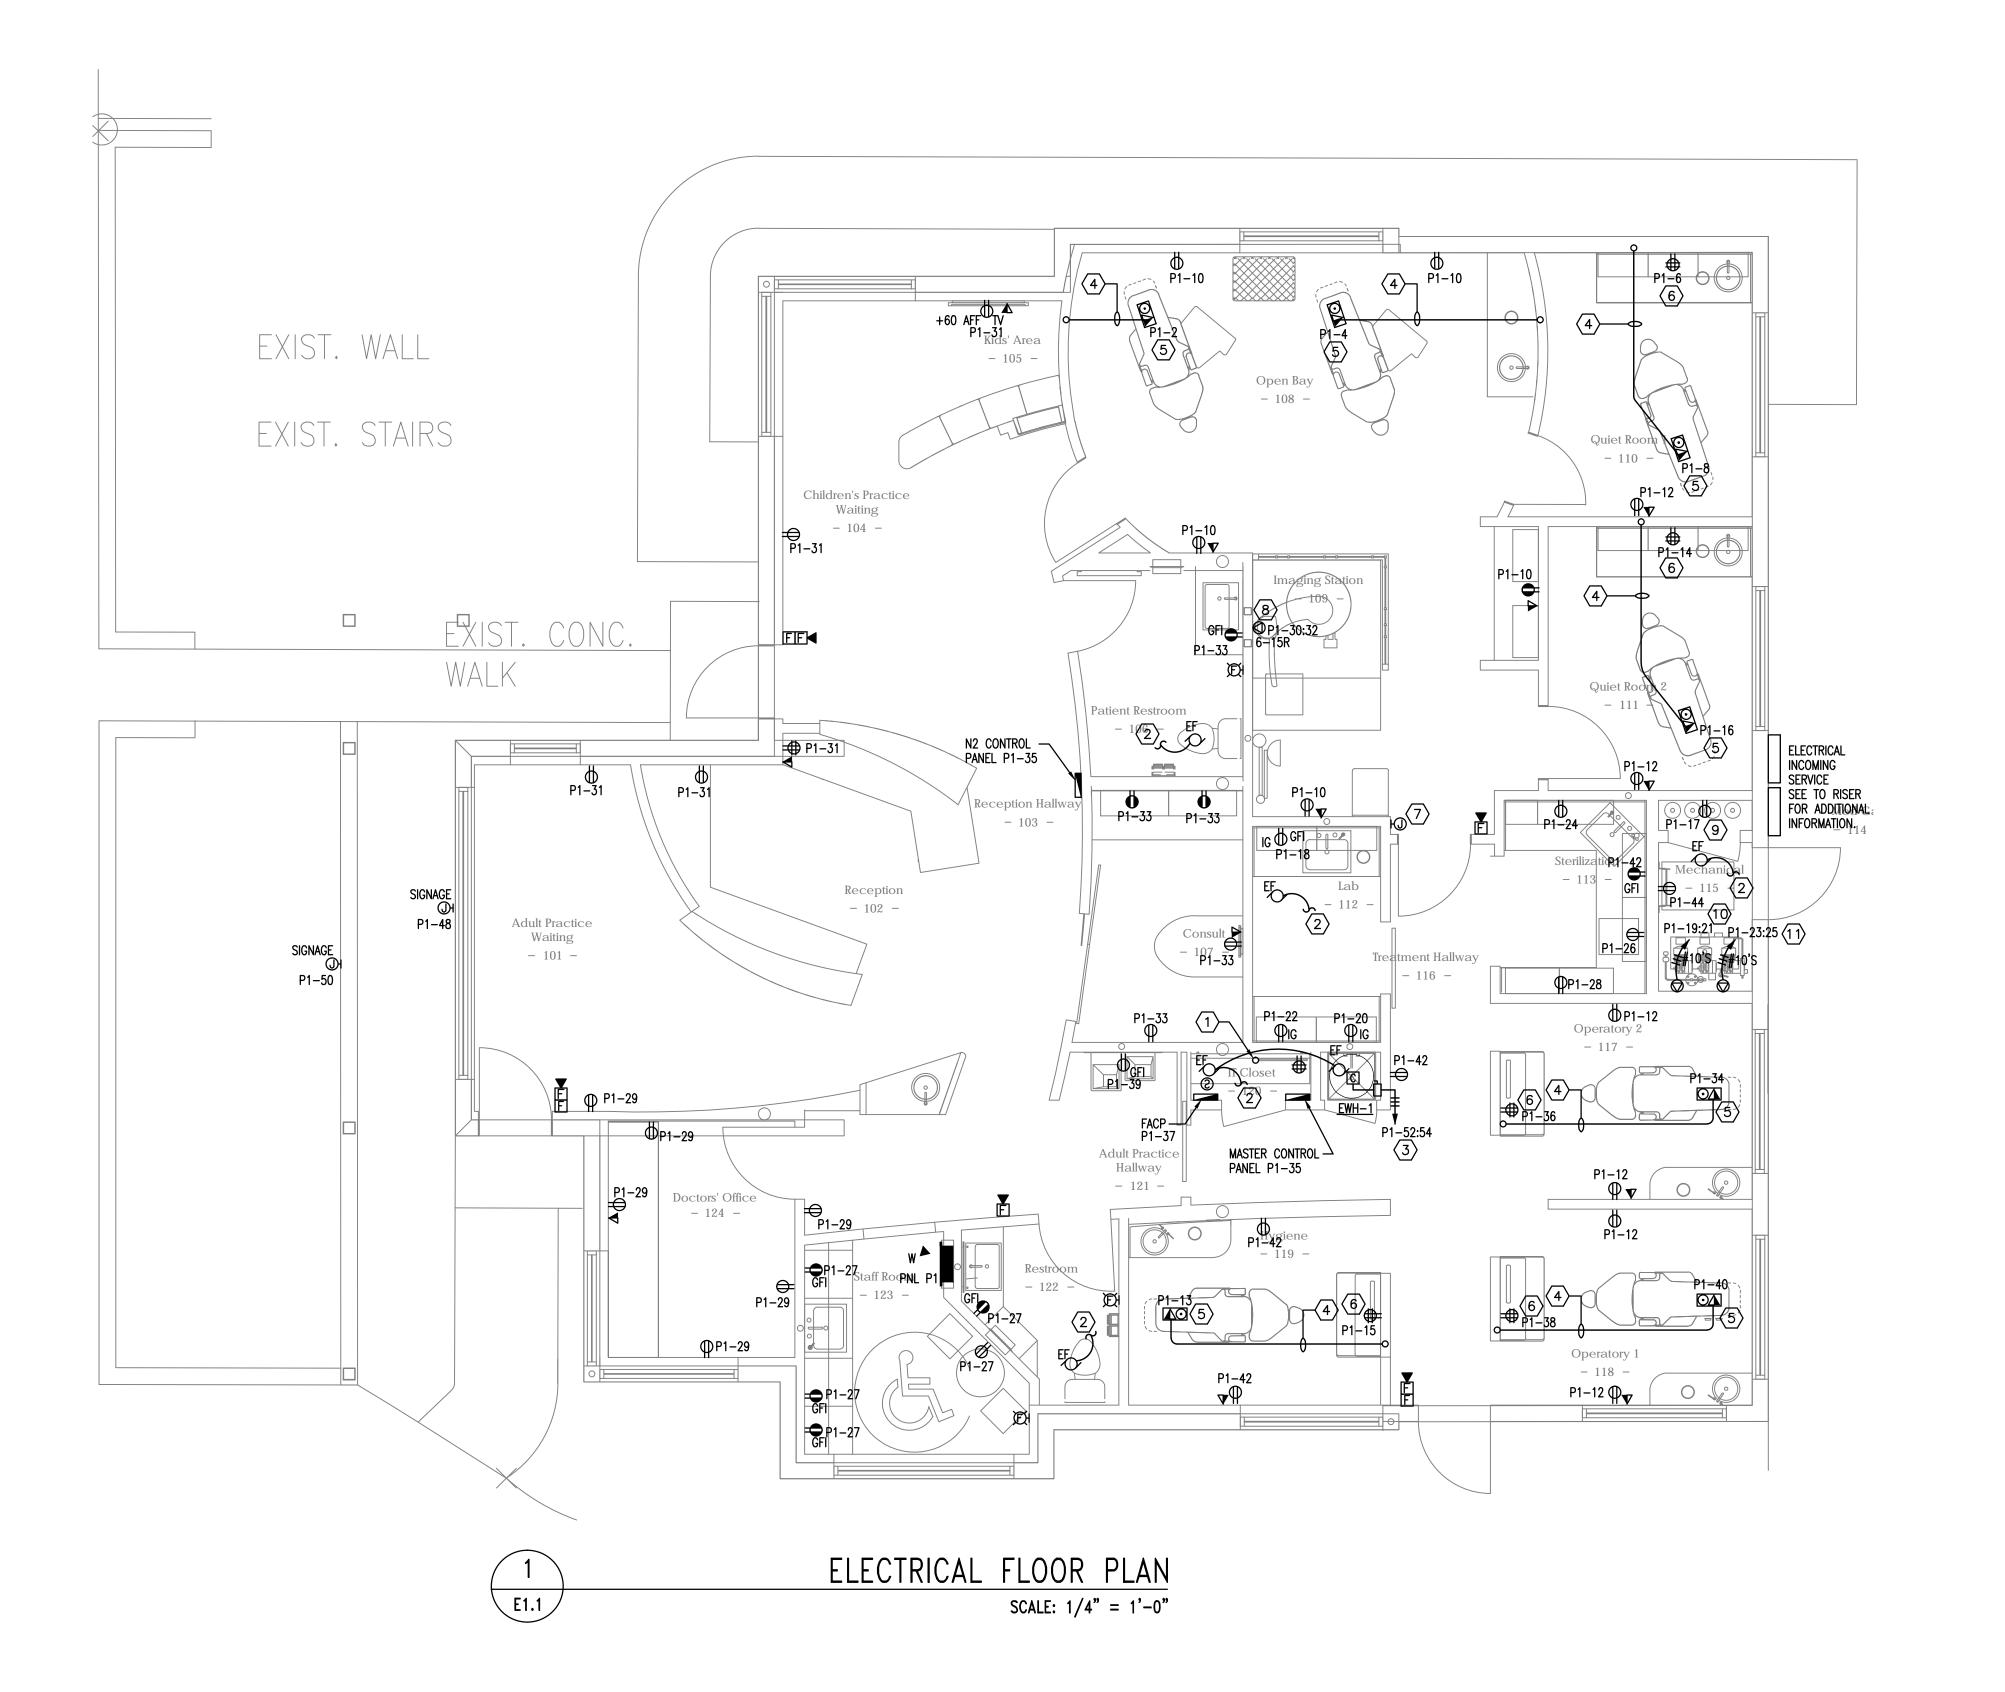

CONCEPT ARCHITECT

JOEARCHITECT

1422 delgany street, suite LL1 denver, colorado 80202 † 720.946.3228 f 720.946.3004 www.joearchitect.com



GENERAL NOTES:

PLAN HEX NOTES:

- 2 EXHAUST FAN: CONNECT TO AREA LIGHT SWITCH FOR CONTROLS. SEE MECHANICAL DRAWINGS FOR EXACT LOCATION. FIELD VERIFY PRIOR TO ROUGH—IN.
- (5) E1 PROVIDE 120V, 10 BRANCH CIRCUIT FOR DENTAL UTLITY. DOUBLE DUPLEX RECEPTACLE WITH 2" CONDUIT FOR E1 TO E1A OR WALL FOR COMPUTER CABLES.
- RECEPTACLE WITH 2" CONDUIT FOR E1 TO E1A OR WALL FOR COMPUTER CABLES.
- $\langle 7 \rangle$ XRAY REMOTE EXPOSURE BUTTON @ 60" AFF . RUN PULL WIRES FROM BOX AT X-RAY HEAD @ 60"AFF TO JUNCTION BOX AT X-RAY REMOTE. MOMENTARY
- PROVIDE 220V, 10 BRAMCH CIRCUIT FPR PANORAMIC X-RAY. PROVIDE A SEPARATE CIRCUIT COORDINATE WITH OWNER REP FOR DETAILS AND EXACT LOCATION. MOUNT RECEPTACLE 36" AFF (NEMA 6-15).
- 2 VOLTAGE SYSTEM. PROVIDE 1" CONDUIT FROM MANIFOLD TO N20 ALARM UNIT. FIELD COORDINATE WITH OWNER REP PRIOR TO ROUGH-IN.
- COORDINATE WITH OWNER'S REP PRIOR TO ROUGH-IN.
- (11) PROVIDE 220V, 10 BRANCH CIRCUIT FOR VACUUM PUMP. FIELD COORDINATE WITH OWNER'S REP PRIOR TO ROUGH-IN.

- 1) REFER TO SHEET EO FOR GENERAL NOTES AND SPECIFICATIONS.
- 2) ALL WIRING AND CONDUIT SHALL BE 2#12, 1#12G, IN 1/2"C, UNLESS OTHERWISE

- ELECTRICAL CONTRACTOR SHALL PROVIDE AND INSTALL A CONDUIT WITH PULL STRING OF PROPER SIZE AND CONSTRUCTION TO MEET REQUIREMENTS OF THE LOCAL TELEPHONE SERVICE PROVIDER.
- ELECTRIC WATER HEATER: SEE EQUIPMENT FEEDER SCHEDULE FOR WIRE, DISCONNECT SWITCH AND CONDUIT SIZES. CONNECT COMPLETE PER N.E.C.
- $\boxed{4}$ PROVIDE 2" CONDUIT ONLY WITH PULLSTRING FOR O.F.C.I. DATA CABLES.
- COORDINATE FINAL ROUGH-IN WITH TEMPLATE PROVIDED BY OWNER REPRESENTATIVE
- 6 E1A PROVIDE 120V, 10 BRANCH CIRCUIT FOR DENTAL UTLITY. DOUBLE DUPLEX COORDINATE FINAL ROUGH-IN WITH TEMPLATE PROVIDED BY OWNER REPRESENTATIVE.
- CONTACT BUTTON PROVIDED BY DOCTOR. LEAVE 18" OF EXTRA WIRE AT EACH END.
- NITROUS OXIDE & OXYGEN MANIFOLD: PROVIDE 120V, 10 BRANCH CIRCUIT FOR LOW
- (10) PROVIDE 220V, 10 BRANCH CIRCUIT FOR A/C COMPRESSOR PUMP. FIELD

WJ WEEKS ARCHITECTURE LLC

1200 EAST HILLCREST STREET, SUITE 200

ORLANDO, FLORIDA 32803

ARCHITECT OF RECORD

407-234-3695

AA 26002407 AR 95341

PROJECT NAME

MAGNOLIA DENTAL CENTER

611 NORTH MAGNOLIA ORLANDO, FLORIDA

PROJECT NUMBER

2013-0023

NAZAK

OWNER/DEVELOPER NAME

HOLDINGS LLC 515 STATE ROAD 436 SUITE 1010 CASSELBERRY, FLORIDA

PROJECT TEAM

No.	Date	Description
1	12-26-13	ZONING VARIANCE APPLICATION
2	3-24-14	PERMIT DOCUMENTS
DRAW	ING NAME:	


RBE CONSULTING SERVICES, LLC

ELECTRICAL POWER

AND SYSTEMS

SCALE: AS INDICATED

PLANS

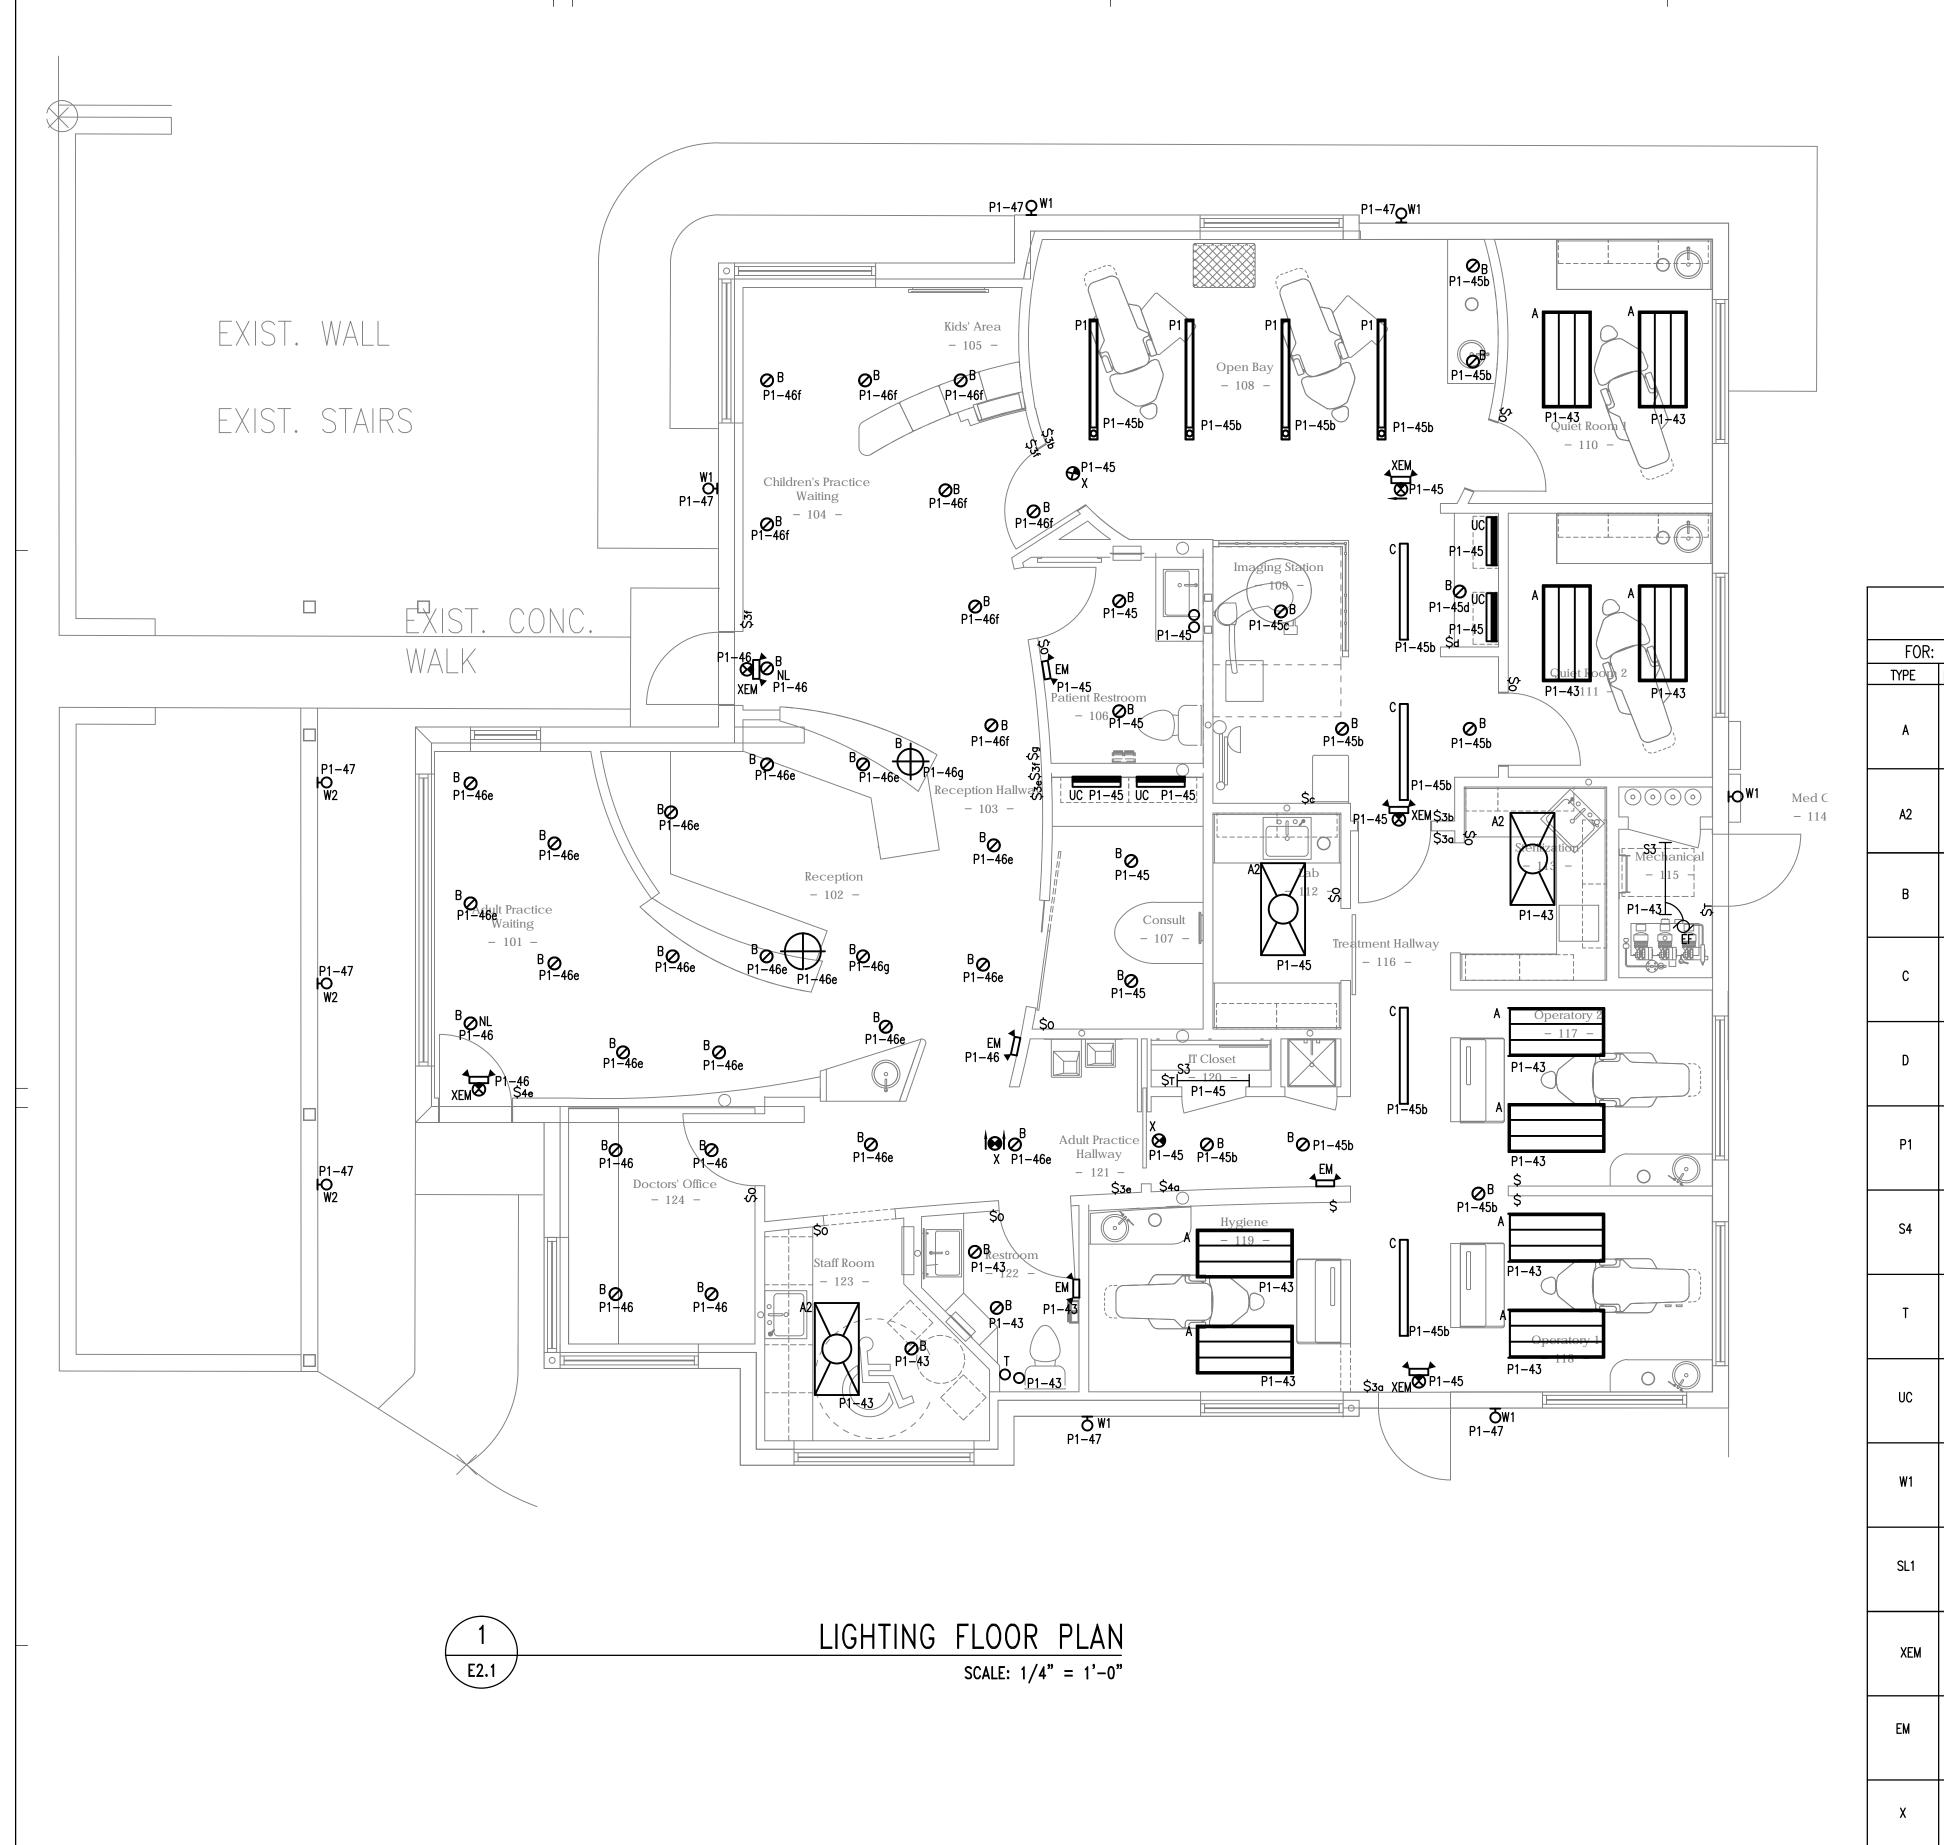

CONCEPT ARCHITECT

JOEARCHITECT

1422 delgany street, suite LL1 denver, colorado 80202 t 720.946.3228 f 720.946.3004 www.joearchitect.com

www.joearchitect.com

GENERAL NOTES:

REFER TO SHEET EO FOR GENERAL NOTES AND SPECIFICATIONS.
 ALL WIRING AND CONDUIT SHALL BE 2#12, 1#12G, IN 1/2"C, UNLESS OTHERWISE NOTED.

3) CONNECT ALL EXIT SIGNS, EMERGENCY BATTERY LIGHTS & NIGHT LIGHTS (N/L) AHEAD OF SWITCH LEG. CONNECT COMPLETE.



WJ WEEKS ARCHITECTURE LLC

1200 EAST HILLCREST STREET, SUITE 200 ORLANDO, FLORIDA 32803 407-234-3695

ARCHITECT OF RECORD

					I IT FIVTIID		
	07/04/44	D.TE.	OLE	E SCHEL	HT FIXTUR		500
AA 26002407 AR 953	03/01/14 LAMPS/FIXT. A	DATE: (APPROVED SUBST.	APPROVED SUBST.	DESIGN SELECTION	MAGNOLIA DENTAL DESCRIPTION	FOR:
PROJECT NAME MAGNOLIA	3–F32T8 4100 DEG. K	120	COOPER LIGHTING	LIGHTOLIER	LITHONIA 2AVG-332MDR-120-GEB10IS	2FT x 4FT RECESSED STATIC FLUORESCENT DIRECT / INDIRECT AND ENERGY SAVING BALLAST.	A
611 NORTH MAGNOLIA ORLANDO, FLORIDA	3–F32T8 4100 DEG. K	120	COOPER LIGHTING	LIGHTOLIER	LITHONIA 2PM4-332-18LD 1/3GEB10IS	2FT x 4FT RECESSED STATIC FLUORESCENT WITH ACRYLIC PRISMATIC LENS AND ENERGY SAVING BALLAST.	A2
PROJECT NUMBER 2013-0023		120	COOPER LIGHTING	LIGHTOLIER	LITHONIA 6VF26-42TRT 609-120	6" COMPACT FLUORESCENT DOWNLIGHT FIXTURE WITH WHITE REFLECTOR AND ELECTRONIC SAVING BALLAST.	В
NAZAK HOLDINGS LLC	2–F32T8 4100 DEG. K	120	COOPER LIGHTING	LIGHTOLIER	TECH LIGHTING UNISON LINEAR SUSPENSION	4FT PENDANT FLUORESCENT AND ENERGY SAVING BALLAST.	С
515 STATE ROAD 436 SUITE 1010 CASSELBERRY, FLORIDA	1-26W 51	120	COOPER LIGHTING	LIGHTOLIER	FOSCARINI GREGG SUSPENSION LIGHT	DECORATIVE SUSPENSION LIGHT FIXTURE	D
PROJECT TEAM	2-F32T8 4100 DEG. K	120	COOPER LIGHTING	LIGHTOLIER	POCAL POINT AVENUE D	PENDANT INDRECT FLUORESCENT SURFACE MOUNTED AND ENERGY SAVING BALLAST.	P1
	2-F32T8 4100 DEG. K	120	COOPER LIGHTING	LIGHTOLIER	LITHONIA WT8-2-32-120GEB10IS	4'-0" FLUORESCENT SURFACE MOUNT LIGHT FIXTURE WITH ACRYLIC DIFFUSER AND ENERGY SAVING BALLAST.	S4
ssue	1-26W T.T C.F.	120	COOPER LIGHTING	LIGHTOLIER	KARTELL EASY PENDANT	PENDANT DECORATIVE LIGHT FIXTURE	T
1 12-26-13 ZONING VARIANCI APPLICATION PERMIT	1–17T8 4100 DEG. K	120	COOPER LIGHTING	LIGHTOLIER	LITHONIA 2UC-117 120-SWR	UNDER CABINET LIGHT FIXTUIRE	UC
2 3-24-14 DOCUMENTS	1-42-TRT 4100 DEG. K	120	COOPER LIGHTING	LIGHTOLIER	LITHONIA WST-42TRTMD-120-PE-LP1	EXTERIOR WALL MOUNT FULL CUT OFF LIGHT FIXTURE.	W 1
	1-42-TRT 4100 DEG. K	120	COOPER LIGHTING	LIGHTOLIER	LITHONIA KAD-250MR3120-SCWASPD04 LP1	AREA LIGHTING SHOEBOX TYPE EXTERIOR LIGHT FIXTURE, TYPE III DISTRIBUTION ON 20'-0" DIRECT BURIED POLE WITH HOUSE SHIELD POLE: STC2510-05X	SL1
	FURNISHED	120	CHLORIDE #	LIGHTALARMS	LITHONIA ECR LED M6	UNIVERSAL MOUNTED COMBINATION EMERGENCY / SINGLE FACE EXIT SIGN WITH BLACK HOUSING, RED LETTERS AND INTEGRAL LEAD CALCIUM BATTERY	XEM
	FURNISHED	120	CHLORIDE #	LIGHTALARMS	LITHONIA ELM2—LED—HO	TWO HEAD NICKEL CADMIUM BATTERY POWERED EMERGENCY LIGHT WITH TEST SWITCH AND INDICATOR LIGHT.	ЕМ
DRAWING NAME:	FURNISHED	120	DAYBRITE	LIGHTALARMS	LITHONIA EDG-1-R-EL	UNIVERSAL MOUNTED SINGLE FACE EXIT SIGN WITH EDGE LIT, RED LETTERS AND INTEGRAL LEAD CALCIUM BATTERY	X


LIGHTING FLOO

SCALE: AS INDICATED

RBE CONSULTING SERVICES, LLC
2875 SPLIT OAK COURT ~ OVEDO, FL 32766 MAIN PHONE LINE: 407.796.3820 ~ FAX LINE: 407-796-3671 WEBSITE: WWW.RBECS.COM ~ ENAIL: RBECSLLC@GMAIL.COM
STRUCTURAL DEPT.: 407.796.3820 ~ EMAIL: RBEATTIE@RBECS.COM ELECTRICAL DEPT.: 407.617.313 ~ EMAIL: FAMILIBIA@RBECS.COM MECHANICAL DEPT.: 407.796.3776 ~ EMAIL: NSHAH@RBECS.COM
ROBERT M. BEATTIE, PE; FLORIDA PE #55426

ERVES ITS
TO THESE
GIGH AND
COULED IN
PERMISSION
C.*.

DRAWING NUMBER:

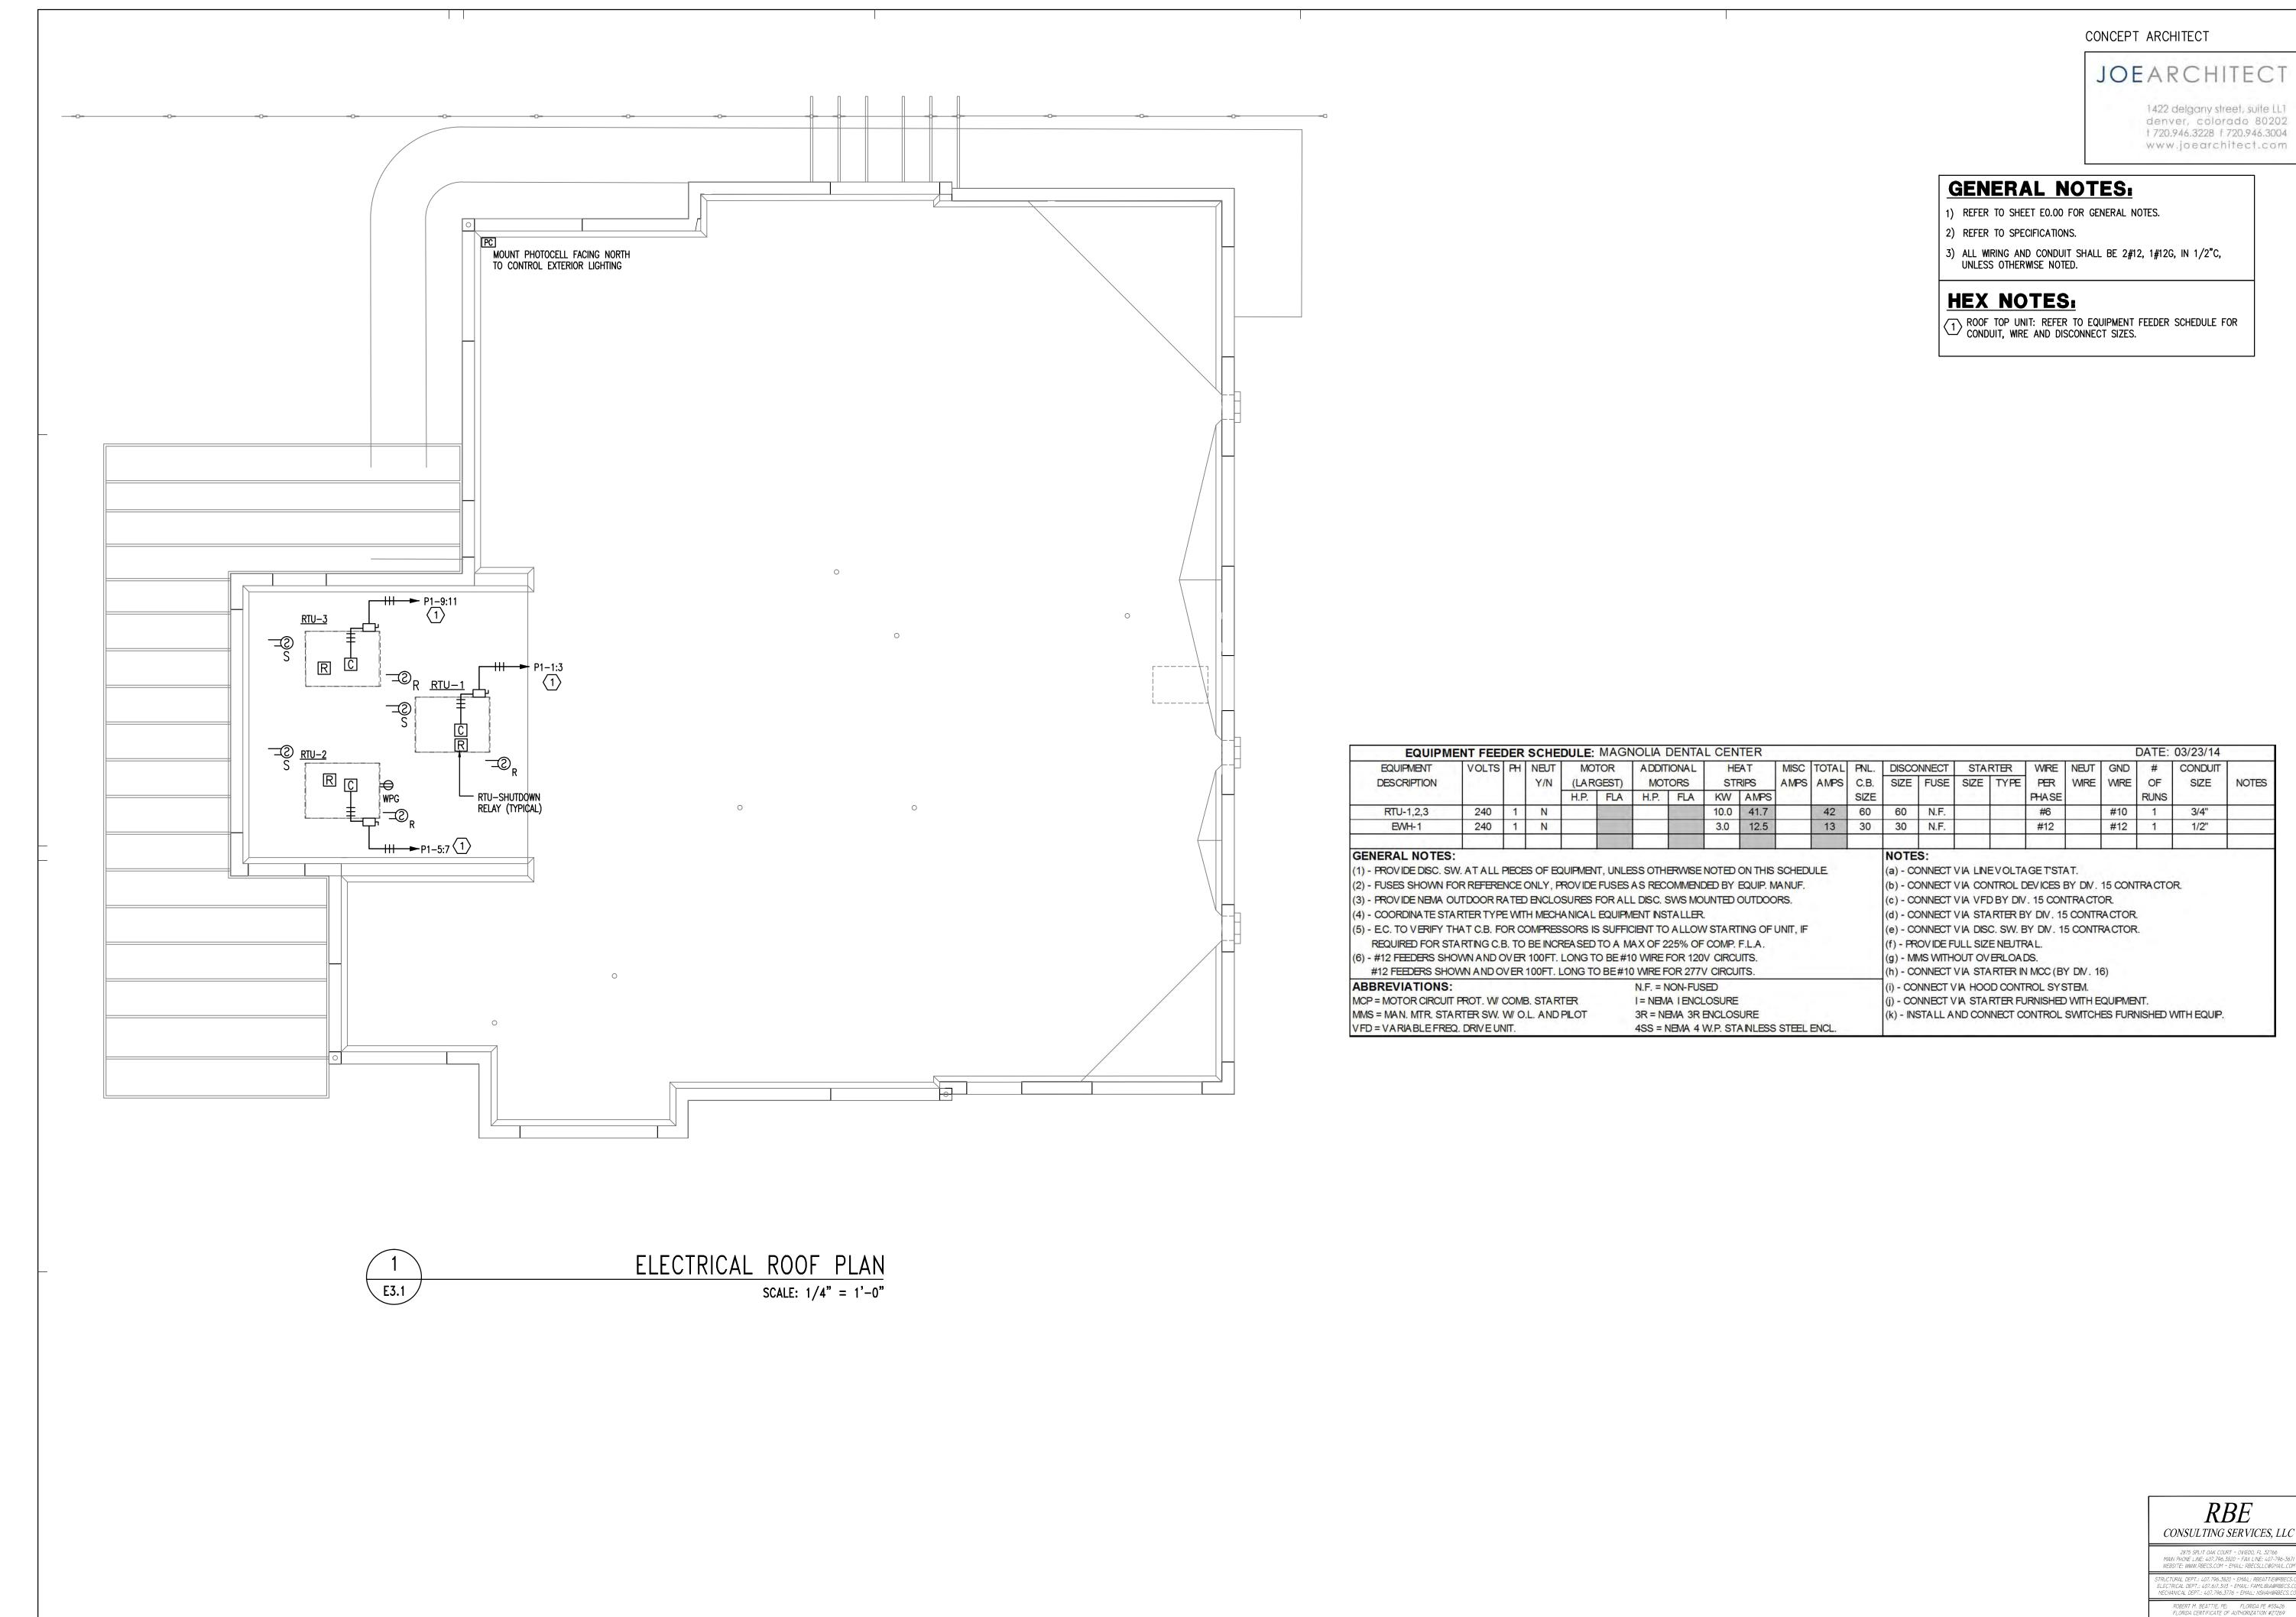

WJ WEEKS ARCHITECTURE LLC

1200 EAST HILLCREST STREET, SUITE 200 ORLANDO, FLORIDA 32803 407-234-3695

ARCHITECT OF RECORD

AA 26002407

PROJECT NAME

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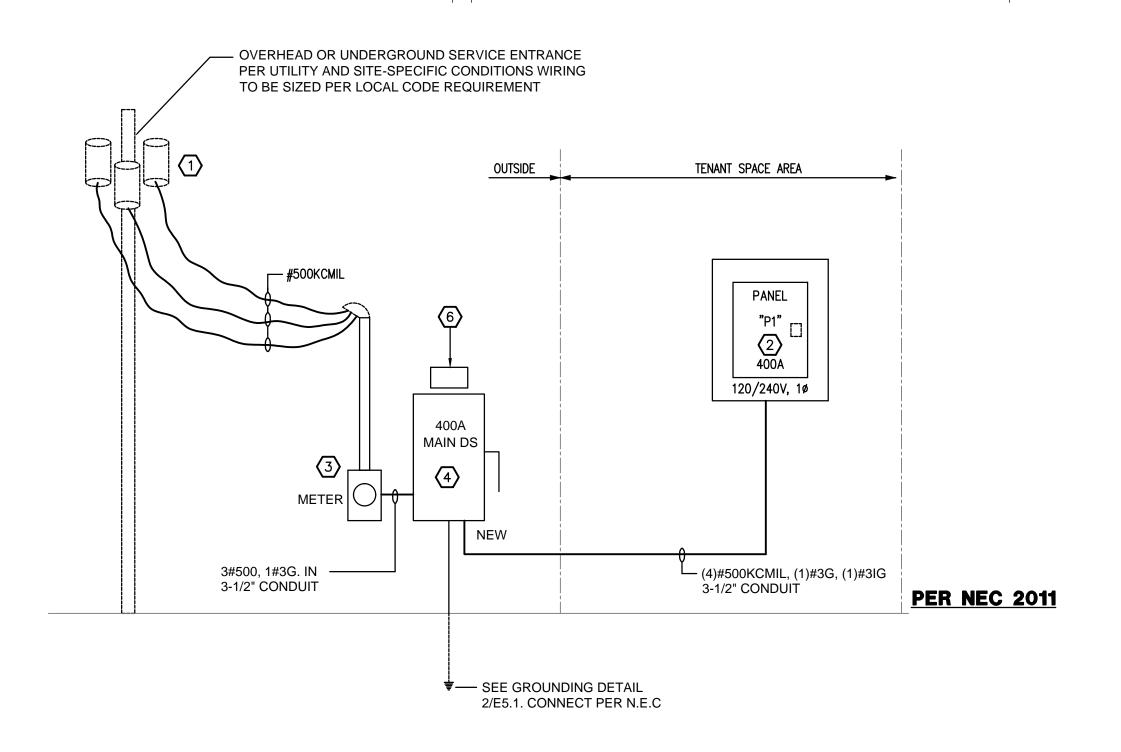
DRAWING NAME:

ELECTRICAL ROOF PLAN

RBECONSULTING SERVICES, LLC


SCALE: AS INDICATED

DRAWING NUMBER:



101	<u> </u>	DEN DIAGI	TAM AND	DETAILS
E4.1				N.T.S.

FEE	DERS FOR:	MAGNOLI	A DENTAL							DATE:	03/23/14	
FEEDER	CIF	FEEDER	FEEDER	FEEDER								
FEEDING	AMPSIZE	VOLTS	PHASE	AMPS	VOLT DROP	PARALLEL	PHASE	NEUTRAL	GROUND	ISOLATED	COPPER/	CONDUIT
					%	RUNS	WIRE	WIRE	WIRE	GROUND	ALUMINUM	SIZE
PNL P1	400	240	1	380	0.08	1	#500	#500	#3	N/A	COPPER	3"
	1 - 0											

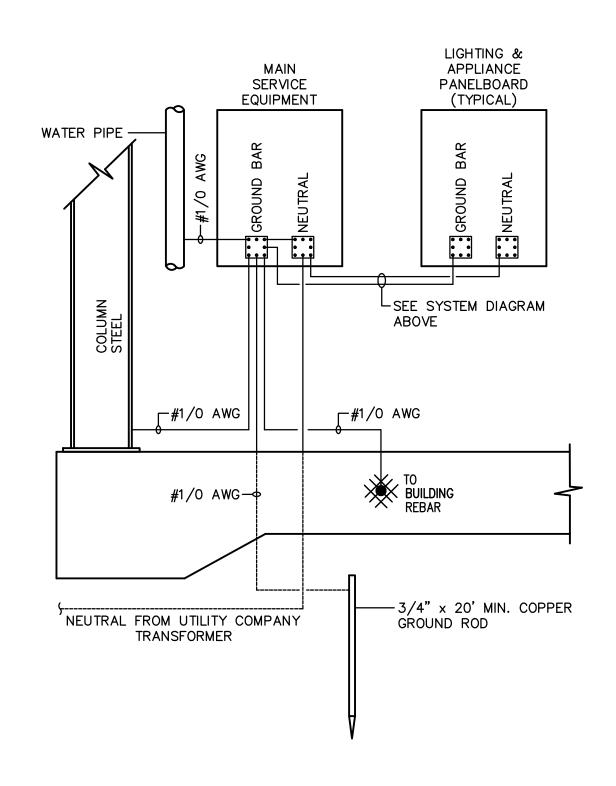

POWER GROUNDING DETAIL E4.1 N.T.S.

	120	MAIN	OPTIO	ONS		Р	ANEL:	P1			AIC RA	ATING	ENCL	OSURE	DATA
VOLTS PH. :	240		S.E. R.	ATED:	N/A		MCB:	400	AMPS		FULLY	RATE	D I	NEMA :	1
PHASE :	1		GFI P	ROT. :	N/A		MLO:		AMPS		(OR	SECT	TIONS :	1
MOUNTING:	FLUSH		SHUNT	TRIP:							SERIE	SRATE	D WIDTH/S	SECT. :	20
MFR:	SQ.D										22	KA		EPTH:	6.0
TYPE :	QO									(MINIM	IUM, SE	E SPE	CIFICATIONS)		
DESCRIPTION	I was a first of the second		AMPS	AMPS		C.B. POLES	CKT.	CKT.	C.B. POLES		7,220,000 72	AMPS	DESCRIPTION	LOAD	
RTU-1	41	12	41		60	2	1	2	1	20	16		DENTAL UTL	16	7
====	41	12		41	===	===	3	4	1	20		16	DENTAL UTL	16	7
RTU-2	41	12	41		60	2	5	6	1	20	16		DENTAL UTL	16	7
====	41	12		41	===	===	7	8	1	20	10	16	DENTAL UTL	16	7
RTU-3	41	12	41	3.1	60	2	9	10	1	20	8	10	RECEPTS	5	2
====	41	12	-11	41	===	===	11	12	1	20	-	9	RECEPTS	6	2
DENTAL UTIL	16	7	16	7.1	20	1	13	14	1	20	16	J	DENTAL UTL	16	7
DENTAL UTIL	16	7	10	16	20	1	15	16	1	20	10	16	DENTAL UTL	16	7
MAINFOLD	10	5	10	10	20	1	17	18	1	202	12	10	XRAY HEAD	12	5
VACUUM PMF	1, 25, 1	8	10	20	30	2	19	20	1	202	12	12	XRAY HEAD	12	5
=====	20	8	20	20	===	===	21	22	1	20	12	12	XRAY HEAD	12	5
A/C PMP	20	8	20	20	30	2	23	24	1	20	12	12	STERILIZER	12	5
=====	20	8	20	20	===	===	25	26	1	20	12	12	STERILIZER	12	5
RECEPTS	5	2	20	8	20	1	27	28	1	20	12	12	STERILIZER	12	5
RECEPTS	5	2	8	0	20	1	29	30	2	20	12	12	XRAY	12	5
RECEPTS	6	2	0	9	20	1	31	32	===	===	12	12	ANA1	12	5
RECEPTS	6	2	9	9	20	1	33	34	1	20	16	12	DENTAL UTL	16	7
MAST CNTRL	200	5	9	10	20	1	35	36	1	20	10	16	DENTAL UTL	16	7
**FACP	5	5	5	10	20	1	37	38	1	20	16	10	DENTAL UTL	16	7
EWC	6	5	5	6	20	1	39	40	1	20	10	16	DENTAL UTL		7
RECEPTS	3	2	3	0	20	1	41	42	1	20	8	10	RECEPTS	6	2
LIGHTS	1500	1	3	13	20	1	43	44	1	20	0	5	CNTRL PNL	5	5
	1 7 - 2 - 1	-	42	13	-	-					12	5	San Anna Connection		-
LIGHTS EXT. WALL	1500	1	13	8	20	1	45	46	1	20	13	12	LIGHTS	1500	5
SITE LTS	500 750		0	0	20	1	47	48		2 Sec. 25	42	12	SIGNAGE SIGNAGE	12	5
PHOTOCELL	750 5	5	8	5	20	1		50	2	20 30	12	13	EWH-1	12	5
to very supplied to	5		0	5	20	1	51	52 54	===	30	40	13	====	13	5
SPACE		22 SUBFE	O ED C.E	OR F	EED-TE		53 LUGS		CATED,	A. Service	13 PPLICA	BLE IF		13	5
			0			2			30		0		SPD		5
				0		===			===			0	===		5

POWER DISTRIBUTION SYSTEM NOTES:

SERVICE TRANSFORMER WITH 240Y/120V, 1PH, 3W SECONDARY AND SOLIDLY GROUNDED NEUTRAL.
COORDINATE EXACT LOCATION AND PROVIDE ALL EQUIPMENT, MATERIAL AND LABOR AS REQUIRED BY THE POWER COMPANY.

2 Branch Panelboard. See Panel Schedules for requirements.

3 PROVIDE METERING AND CT CABINET PER POWER COMPANY REQUIREMENTS.

4 600V, 2P, HEAVY DUTY DISCONNECT SWITCH, SERVICE ENTRANCE RATED, WITH SOLID NEUTRAL, CLASS 'L' FUSES (SIZE AS SHOWN) AND NEMA 3R ENCLOSURE. PROVIDE AND INSTALL DISCONNECT SIGN IN ACCORDANCE WITH REQUIREMENTS OF THE LOCAL AUTHORITY HAVING JURISDICTION.

BID ALTERNATE FOR PAD MOUNTED SERVICE TRANSFORMER WITH 208Y/120V, 3PH, 4W SECONDARY AND SOLIDLY GROUNDED NEUTRAL, FOR UNDERGROUND SERVICE. COORDINATE EXACT LOCATION AND PROVIDE ALL EQUIPMENT, MATERIAL AND LABOR AS REQUIRED BY THE POWER COMPANY.

PROVIDE 3" HIGH WHITE LETTERS PLACARD STATING "SERVICE DISCONNECT". DISPLAY PLACARD IN A CONSPICUOUS PLACE NEXT TO THE MAIN DISCONNECT SWITCH.

BRANCH CIRCUIT WIRING NOTES:

WIRING IS SHOWN ON DRAWINGS ONLY FOR SPECIFIC ROUTES OR SPECIAL

WIRING AND CONDUIT SHALL BE REQUIRED BETWEEN ALL OUTLETS INDICATED WITH CIRCUIT NUMBERS AND PANEL DESIGNATIONS.

, ALL SWITCH CONTROLS SHALL BE PROVIDED WITH WIRING AND CONDUIT AS

4. ALTHOUGH ALL BRANCH CIRCUIT WIRE AND CONDUIT IS NOT SHOWN, IT IS INTENT OF THESE DOCUMENTS THAT A COMPLETE BRANCH CIRCUIT WIRING SYSTEM BE INSTALLED.

PROVIDE A GREEN GROUND CONDUCTOR IN ALL CIRCUITS, APPROPRIATELY SIZED INCREASE CONDUITS TO ACCOMMODATE GROUND CONDUCTOR.

6. UNLESS SHOWN OTHERWISE (BRANCH CIRCUITING INSTRUCTIONS): 1600 WATTS MAXIMUM PER 20A/1P BRANCH CIRCUIT,

A. UNLESS SHOWN OTHERWISE.

B. 6 CONV. OUTLETS MAXIMUM PER 20A/1P BRANCH CIRCUIT.

FEEDER NOTES:

<u>VOLTAGE DROP</u> FEEDER CONDUCTORS SHALL BE SIZED FOR A MAXIMUM VOLTAGE DROP OF 2 PERCENT AT DESIGN LOAD.

CONCEPT ARCHITECT

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ARCHITECT OF RECORD

AA 26002407

PROJECT NAME

MAGNOLIA DENTAL CENTER

AR 95341

611 NORTH MAGNOLIA ORLANDO, FLORIDA

PROJECT NUMBER

2013-0023

NAZAK

OWNER/DEVELOPER NAME

HOLDINGS LLC

515 STATE ROAD 436 **SUITE 1010** CASSELBERRY, FLORIDA

PROJECT TEAM

ZONING VARIANCE APPLICATION PERMIT DOCUMENTS 3-24-14

POWER RISER DIAGRAM, DETAILS AND SCHEDULES

SCALE: N.T.S.

DRAWING NUMBER:

RBE

CONSULTING SERVICES, LLC